

TANDEM HOUSE 2 3634 WYANDOT ST - ADDITION

PROJECT INFORMATION

PROJECT DESCRIPTION:

SINGLE FAMILY ADDITION AND NEW DETACHED GARAGE

CODE JURISDICTION:

2018 INTERNATIONAL RESIDENTIAL CODE (IRC) 2019 DENVER AMENDMENTS DENVER GREEN CODE - TARGETING LEED PLATINUM **DENVER ZONING CODE**

IECC COMPLIANCE METHOD: PERFORMANCE

ZONING: U-TU-B

BUILDING FORM: TANDEM HOUSE WITH DETACHED GARAGE

3634 WYANDOT ST, DENVER, CO 80211 (FRONT TANDEM HOUSE, ZONE LOT A) 3632 WYANDOT ST, DENVER, CO 80211 (REAR TANDEM HOUSE, ZONE LOT B)

BUILDING COVERAGE CALCULATIONS

LOT SIZE: 6,250 SF MAXIMUM ALLOWABLE BUILDING COVERAGE: 37.5% OR 2,344 SF ZONE LOT A TANDEM HOUSE (3634 WYANDOT ST): 861 SF PROPOSED DETACHED GARAGE: 1,140 SF 2,309 SF ZONE LOT B TANDEM HOUSE (3632 WYANDOT): TOTAL PROPOSED BUILDING COVERAGE:

NEW CONDITIONED SPACE EQUALS 861 SF

DENVER AFFORDABLE HOUSING GROSS AREA EQUALS 861 SF

LEGAL DESCRIPTION

26, A DISTANCE OF 50.02 FEET, MORE OR LESS, TO THE TRUE POINT OF BEGINNING. TOTAL AREA OF ZONE LO A IS 3609.1 SQUARE FEET OR 0.0828 ACRE.

ADDITION, CITY AND COUNTY OF DENVER, STATE OF COLORADO, DESCRIBED AS FOLLOWS: COMMENCING AT THE NORTHWEST CORNER OF SAID LOT 25; THENCE EAST AND ALONG THE NORTH LINE OF SAID LOT 25. A DISTANCE OF 58.91 FEET, TO THE POINT OF BEGINNING; THENCE SOUTH AND PARALLEL WITH THE WEST LINE OF SAID LOTS 25 AND 26, A DISTANCE OF 43.02 FEET; THENCE EAST AND PARALLEL WITH THE NORTH LINE OF SAID LOT 25, A DISTANCE OF 39.09 FEET; THENCE NORTH AND PARALLEL WITH THE WEST LINE OF SAID LOTS, A DISTANCE OF 7.40 FEET; THENCE EAST AND PARALLEL WITH THE NORTH LINE OF SAID LOT 25, A DISTANCE OF 27.00 FEET, MORE OR LESS, TO A POINT ON THE EAST LINE OF SAID LOT 26, SAID POINT BEING 14.40 FEET NORTH OF THE SOUTHEAST CORNER OF SAID LOT 26; THENCE NORTH AND ALONG THE EAST LINE OF SAID LOTS 25 AND 26, 35.62 FEET, MORE OR LESS, TO IHE NORTHEAST CORNER OF SAID LOT 25: THENCE WEST AND ALONG THE NORTH LINE OF SAIF LOT 25, A DISTANCE OF 66.09 FEET, MORE OR LESS, THE TRUE POINT OF BEGINNING.TOTAL AREA OF ZONE LOT B IS 2,643.4 SOUARE FEET OR 0.0607 ACRE.

PROJECT TEAM

AMINA N RANK, SCOTT A 3632 WYANDOT STREET

DENVER, CO 80211

ARCHITECT / CONTRACTOR

S A RANK LLC 3632 WYANDOT STREET DENVER, CO 80211 720.315.0625 SARANKLLC@GMAIL.COM

ENERGY CONSULTANT; LEED GREEN RATER

ENERGYLOGIC P.O. Box N BERTHOUD, CO 80513 970.532.3220

GEOTECHNICAL ENGINEER

KORDZIEL ENGINEERING, INC. PO BOX 16267 GOLDEN, CO 80402 303.216.1919

STRUCTURAL ENGINEER

APEX ENGINEERING (FOUNDATION OBSERVATION)

SHEET LIST Number Sheet Name A-0.01 **COVER SHEET** SPECIFICATIONS AND SCHEDULES IECC COMPLIANCE REPORTS A-1.00 DEMOLITION PLAN A-1.01 SITE PLAN A-1.02 SUDP & UTILITY PLAN A-2.01 FLOOR PLANS A-2.02 **ELEVATIONS** A-2.03 SECTIONS A-2.04 SECTIONS A-2.05 SIP DETAILS GARAGE ELEVATIONS & SECTIONS E-1.00 ELECTRICAL PLANS M-1.00 MECHANCIAL FLOOR PLANS P-1.00 PLUMBING PLANS FOUNDATION PLANS & NOTES STRUCTURAL PLANS GARAGE PLANS & DETAILS S-1.03 STRUCTURAL DETAILS & MISC. DETAILS

ZONING LAND USE TABLE					
Building Form on Zone Lot Habitable Story	Zoning Land Use(s)	Gross Floor Area (SF)			
Tandem House Building	Tandem House Building Form (Zone lot A - 3634 Wyandot)				
Basement (Existing)	One Unit Dwelling	861 SF			
1st Floor (Existing)	One Unit Dwelling	861 SF			
2nd Floor (Addition)	One Unit Dwelling	861 SF			
Tandem House Building Form (Zone lot B - 3632 Wyandot)					
Basement	One Unit Dwelling	621 SF			
1st Floor	(1) One Unit Dwelling	759 SF			
IST FIOOI	(2) Vehicle Parking	344 SF			
2nd Floor	One Unit Dwelling	1140 SF			
Detached Garage Building Form					
1st Floor	Vehicle Parking	308 SF			

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Tandem House 2

3634 WYANDOT ST DENVER, CO 80211

REV	DESCRIPTION	DATE
	CONSTRUCTION DOCUMENTS	01.29.2021

COVER SHEET

2020-CO1 Project number 01.29.2021 Drawn by ANR

A-0.01

Scale

PROJECT DESCRIPTION

THE PARCEL(S) ON THE SUBJECT ZONE LOT HAVE PREVIOUSLY BEEN RECONFIGURED INTO ZONE LOT A (3634 WYANDOT) AND ZONE LOT B (3632

THE PROJECT CONSISTS OF A PARTIAL DEMOLOTION OF AN EXISTING 861 SF SINGLE FAMILY RESIDENCE, WITH THE ADDITION CONSISTING OF A LEVEL 2 MATCHING THE SIZE OF THE EXISTING FOOTPRINT, AND A NEW DETACHED

THE BASEMENT HEAD HEIGHT WILL BE RAISED TO CURRENT CODES, AND NEW EXTERIOR WALLS WILL BE CONSTRUCTED TO MEET CURRENT ENERGY AND BUILDING CODES.

NO NEW EXCAVATION OR SHORING IS REQUIRED.

IECC PERFORMANCE PATH NARRATIVE

THE FOLLOWING ARE FEATURES OF THE PROPOSED DESIGN THAT HAVE BEEN MODIFIED FROM THE STANDARD REFERENCE DESIGN:

- FRAMING/INSULATION: STRUCTURAL INSULATED PANELS (SIP) ARE USED AS THE PRIMARY EXTERIOR WALLS AND ROOF, PROVIDING CONTINUOUS INSULATION WITH MINIMAL THERMAL BREAKS.
- AIR SEALING: A FLUID APPLIED WEATHER RESISTIVE BARRIER SYSTEM WILL BE UTILIZED AT THE EXTERIOR WALLS STARTING AT THE SILL PLATE, WHICH GREATLY REDUCES AIR INFILTRATION. A HIGH PERFORMACE ROOF UNDERLAYMENT WILL BE USED, AND INTERIOR
- SEAM TAPE WILL BE UTILIZED. TARGET ACH 50 IS <1 HEAT PUMP: ELECTRIC HEAT PUMP DUCTLESS MINI-SPLIT PROVIDED TO
- MEET ALL HEATING AND COOLING NEEDS. HRV: HIGH EFFICIENCY HEAT RECOVERY VENTILATER USED TO MEET
- FRESH AIR REQUIREMENTS WITHOUT LOSING CONDITIONED AIR. HOT WATER: MULTIPLE ELECTRIC ON DEMAND INSTANT WATER HEATER PROVIDED TO REDUCE PLUMBING RUNS AND WASTED
- APPLIANCES: ALL ENERGY STAR APPLIANCES, INCLUDING HEAT PUMP
- ELECTRIC DRYER WITH NO EXTERIOR VENTING REQUIRED. SOLAR: 2.0 KW PV ARRAY PROVIDED TO OFFSET ELECTRICAL USAGE.

SPECIFICATIONS

DIVISION 01 00 00 GENERAL INFORMATION

01 25 00 SUBSTITUTIONS

ARCHITECT MUST APPROVE ANY AND ALL ALTERNATE MATERIALS OR MATERIAL SUBSTITUTIONS NOT IDENTIFIED WITHIN PROJECT DOCUMENTS.

01 35 00 PROJECT SUSTAINABILITY

PROJECT IS TARGETING LEED PLATINUM CERTIFICATION UNDER USGBC LEED FOR HOMES VERSION 4.1; ALL PROJECT SUBMITTALS AND VERIFICATION SHALL CONFORM TO PROJECT REQUIREMENTS AS DIRECTED BY THE ARCHITECT.

DIVISION 03 00 00 CONCRETE

03 31 00 FORMS AND ACCESSORIES USE CONSTRUCTION FORMS THE THE EXACT SIZE, SHAPE LINES AND

DIMENSIONS SHOWN AND AS REQUIRED TO OBTAIN ACCURATE ALIGNMENT, LOCATION, GRADES AND LEVEL AND PLUMB WORK.

03 32 00 CONCRETE REINFORCING STEEL

1. STEEL REINFORCING SHALL COMPLY WITH REQUIREMENTS OF ASTM A615, A706, OR A996. MINIMUM YIELD STRENGTH SHALL BE 40,000 PSI (GRADE 40, 276 MPa).

2. REINFORCEMENT SHALL BE SECURED IN THE PROPER LOCATION IN THE FORMS WITH TIE WIRE OR TOHER BAR SUPPOERT SYSTEM TO PREVENT DISPLACEMENT DURING CONCRETE PLACEMENT. REINFORCING IN CONCRETE CAST AGAINST THE EARTH SHALL HAVE A MINIMUM COVER OF 3". MIN. COVER FOR REINFORCEMENT IN CONCRETE CAST IN REMOVABLE FORMS THAT WILL BE EXPOSED TO THE EARTH OR WEATHER SHALL BE 1-1/2" FOR NO. 5 BARS AND SMALLER, AND 2" FOR FOR NO.6 BARS AND LARGER. FOR CONCRETE NOT EXPOSED TO EARTH OR WEATHER, MINIMUM COVER SHALL BE 3/4".

03 33 00 CAST IN PLACE CONCRETE1. CONCRETE SHALL HAVE A MINIMUM SPECIFIED COMPRESSIVE STRENGTH OF 3,000 PSI.

2. THE MAXIMUM WEIGHT OF FLY ASH, OTHER POZZOLANS, SILICA FUME, SLAG OR BLENDED CEMENTS THAT IS INCLUDED IN CONCRETE MIXTURES FOR FOR GARAGE FLOOR SLABS AND FOR EXTERIOR PORCHES AND STEPS THAT WILL BE EXPOSED TO DEICING CHEMICALS SHALL NOT EXCEED THE PERCETAGES OF TOTAL WEIGHT OF CEMENTITIOUS MATERIALS SPECIFIED IN SETION 19.3.3.4 OF ACI 318.

3. MATERIALS USED TO PRODUCE CONCRETE, AND CONCRETE ITSELF SHALL CONFORM TO REQUIREMENTS OF IRC SECTION R608.5.1 OR ACI 318.

4. ALL CONCRETE MIX DESIGNS TO BE SUBMITTED TO ENGINEER FOR FINAL APPROVAL PRIOR TO PLACEMENT.

DIVISION 06 00 00 WOOD PLASTICS AND COMPOSITES

06 12 00 STRUCTURAL INSULATED PANELS (SIPS) 1.COMPLIANCE SHALL BE MET WITH IRC SECTION R610 FOR STRUCTURAL INSULATED PANEL WALL CONSTRUCTION UNLESS OTHERWISE NOTED.

SEE DIVISION 07 FOR SIP R VALUES

DIVISION 07 00 00 THERMAL AND MOISTURE PROTECTION

07 23 00 INSULATION

SIP R-VALUES PER MANUFACTURER AS FOLLOWS:

6 1/2" THICK PANELS (WALLS): R-22.6 @ 75DEG F; R-24.3 @ 40DEG F 10 1/4" THICK PANELS (ROOFS): R-37 @ 75DEG F; R-39.9 @ 40DEG F

SPRAY FOAM TO MATCH ADJACENT R-VALUES AT A MINIMUM (RIM BOARDS, ROOF-TO-WALL, ETC).

07 25 00 WEATHER BARRIERS

TANDEM HOUSE VERTICAL EXTERIOR WALLS SHALL UTILIZE A FLUID APPLIED WEATHER RESISTIVE BARRIER SYSTEM. PRODUCT SHALL BE PROSOCO BRAND OR EQUAL INCLUDES JOINT & SEAM FILLER, FLASHING, AND WRB.

07 30 05 ROOFING UNDERLAYMENT

TANDEM HOUSE ROOF UNDERLAYMENT SHALL BE SIGA MAJCOAT MEMBRANE SYSTEM.

DIVISION 08 00 00 OPENINGS

08 81 00 WINDOWS

ALL WINDOWS SHALL BE MANUFACTURED BY ALPEN

ALL GLASS TO BE TRIPLE PANE; REFER TO WINDOW SCHEDULE FOR WINDOW PARAMETERS.

DIVISION 09 00 00 FINISHES

1. ALL FINISHES TO BE APPROVED BY OWNER PRIOR TO INSTALLATION

DIVISION 23 00 00 HVAC

1. MANUAL J CALACULATIONS TO BE VERIFIED WITH ENGINEER, OWNER AND ENERGY RATER PRIOR TO FINAL SELECTION OF EQUIPMENT.

DIVISION 31 00 00 EARTHWORK

1. ALL EARTHWORK SHALL BE PERFORMED IN ACCORDANCE WITH GEOTECHNICAL REPORT PREPARED BY KORDZIEL ENGINEERING, DATED SEPTEMBER 17, 2020 PROJECT NUMBER 1959B.

2.. FILL MATERIAL IS SUBJECT TO THE APPROVAL OF THE GEOTECHNICAL ENGINEER. ORGANIC MATERIALS AND DEBRIS SHOULD BE REMOVED FROM THE FOUNDATION AREA AND WASTED OFF SITE.

3. ALL FOOTINGS MUST BE SUPPORTED BY NATIVE SOIL OR PROPERLY COMPACTED STRUCTURAL FILL. ANY SOILS LOOSENED BY THE EXCAVATION OR FORMING PROCESS SHOULD BE REMOVEDFROM THE FOOTING AREAS PRIOR PRIOT TO STRUCTURAL FILL AND/OR CONCRETE. SOILS IN THE FOOTING EXCAVATION SHOULS NOT BE ALLOWED TO DRY EXCESSIVELY.

4. BACKFILL SHAL BE PLACED IN 12" MAXIMUM LIFTS AND COMPACTED TO MINIMUM 90% DENSITY AT EACH LIFT.

5. ALL FINISH GRADE TO SLOPE AWAY FROM BUILDING PERIMETERS FOR POSITIVE DRAINAGE.

DIVISION 48 00 00 ELECTRICAL POWER GENERATION

1. SOLAR PANELS TO BE MIA SOLE BRAND MODEL FLEX-03N FLEXIBLE CIGS MODULES. MODULES ADHERE DIRECTLY TO STANDING SEAM ROOF WITH NO ADDITIONAL RACKS REQUIRED. MODULE WEIGHT IS 5.9 LBS, OR 0.6 LB/FT2. MODULE THICKNESS IS 0.1".

2. SOLAR MODULES AND COMPONENTS SHALL MEET REQUIREMENTS PER IRC SECTION R324 AND R907, INCLUDING BEING LISTED AND LABELED IN ACCORDANCE WITH UL1741. IT SHALL BE DESIGNED AND COMPLY WITH REQUIREMENTS FOR WIND RESISTANCE, FIRE CLASSIFICATION, ROOF LIVE LOAD AT ACCESS AND PATHWAYS, AND SHALL BE INSTALLED ACCORDING TO THE MFR'S INSTRUCTIONS.

	Window Schedule								
Type Mark	Count	Height	Width	Operation	Model	U-Factor	SHGC	Sill Height	Comments
21	3	1' - 4"	2' - 0"	Hopper	Tyrol Series	0.17	0.24	5' - 0"	Basement Replacements
22	9	4' - 0"	3' - 0"	Single Hung	Zenith Series	0.19	0.26		Egress in BRs
23	1	2' - 6"	4' - 7"	Hopper	Tyrol Series	0.17	0.24	4' - 4"	
27	8	1' - 7 1/2"	2' - 6"	Hopper	Tyrol Series	0.17	0.24		
44	1	4' - 0"	3' - 0"	Tilt & Turn	Tyrol Series	0.17	0.24	3' - 0"	Basement Foress

WINDOW NOTES

GLAZING TO BE MANUFACTURED BY ALPEN WINDOWS

U-VALUE & SHGC ARE NFRC FULL-FRAME/TOTAL UNIT PERFORMANCE

Door Schedule					
Mark	Count	Description	Width	Height	
D-10	5	Interior Passage	2' - 6"	6' - 8"	
D-11	1	Bedroom 2	2' - 4"	6' - 8"	
D-12	8	Interior Closet/Bath	2' - 0"	6' - 8"	
D-13	1	Interior Passage	2' - 6"	6' - 8"	
D-14	2	Barn Door and Track	0' - 0"	0' - 0"	
D-17	2	Bi-Fold Closets	2' - 0"	7' - 0"	
D-20	1	Main Entry	3' - 0"	7' - 0"	
D-21	3	Side Lites		7' - 0"	
D-27	1	Side Entry	3' - 0"	8' - 0"	
D-31	1	Garage Passage	3' - 0"	7' - 0"	
D-35	1	OH Garage	9' - 0"	7' - 0"	

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Tandem House 2

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REV	DESCRIPTION	DATE
	CONSTRUCTION DOCUMENTS	01.29.2021

SPECIFICATIONS AND SCHEDULES

Pro	ject number	2020-CO1
Dat	e	01.29.2021
Dra	wn by	SAR
Che	ecked by	ANR

Scale



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THE FOLLOWING ITEMS ARE INCLUDED AS PART OF THE PERMIT SUBMITTAL PACKAGE (IECC PDF):


- 1. RESIDENTIAL COMPLIANCE CHECKLIST IECC PERFORMANCE PATH
- 2. MANUAL J AND S REPORTS
- 3. 2018 IECC COMPLIANCE REPORT INCLUDING HERS SCORE AND ERI NUMBER, PERFORMED BY ENERGYLOGIC (SEPARATE COVER & E-SIGNATURE)
- 4. LEED V4.1 PRELIMINARY SCORECARD


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	CONSTRUCTION DOCUMENTS	01.29.2021


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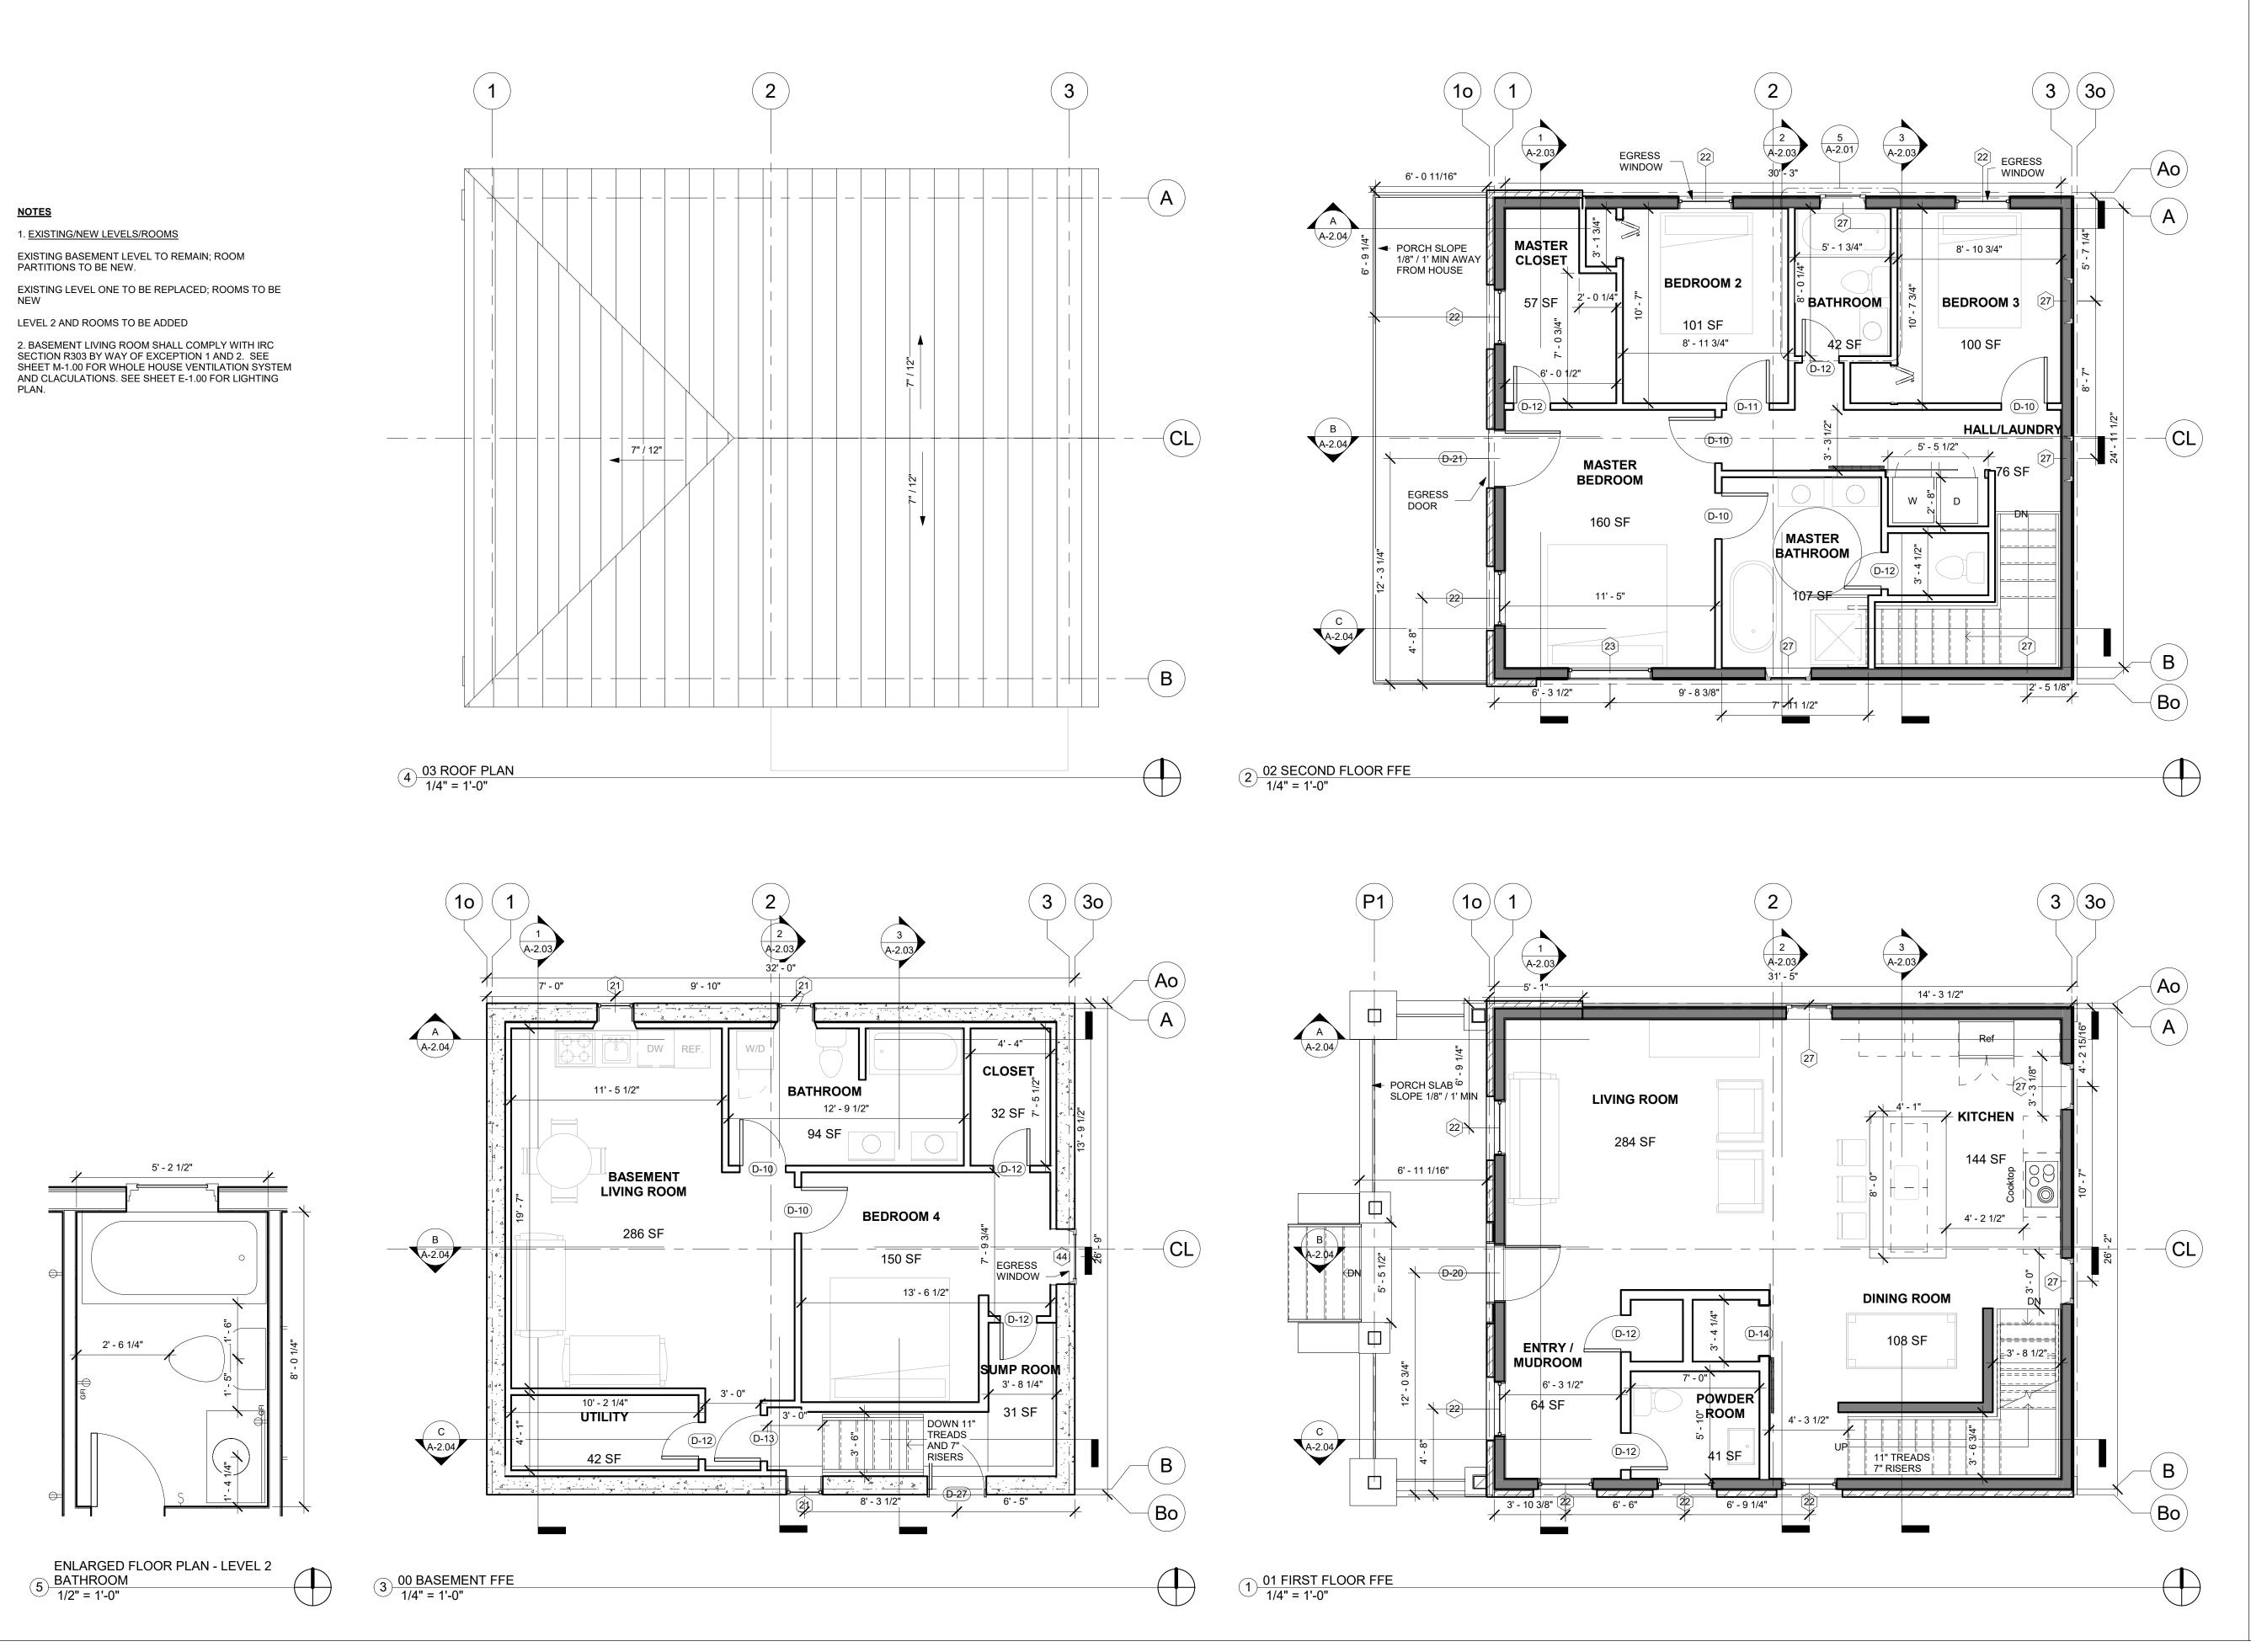
Project number	2020-CO1
Date	01.29.2021
Drawn by	Author
Checked by	Checker

A-0.03




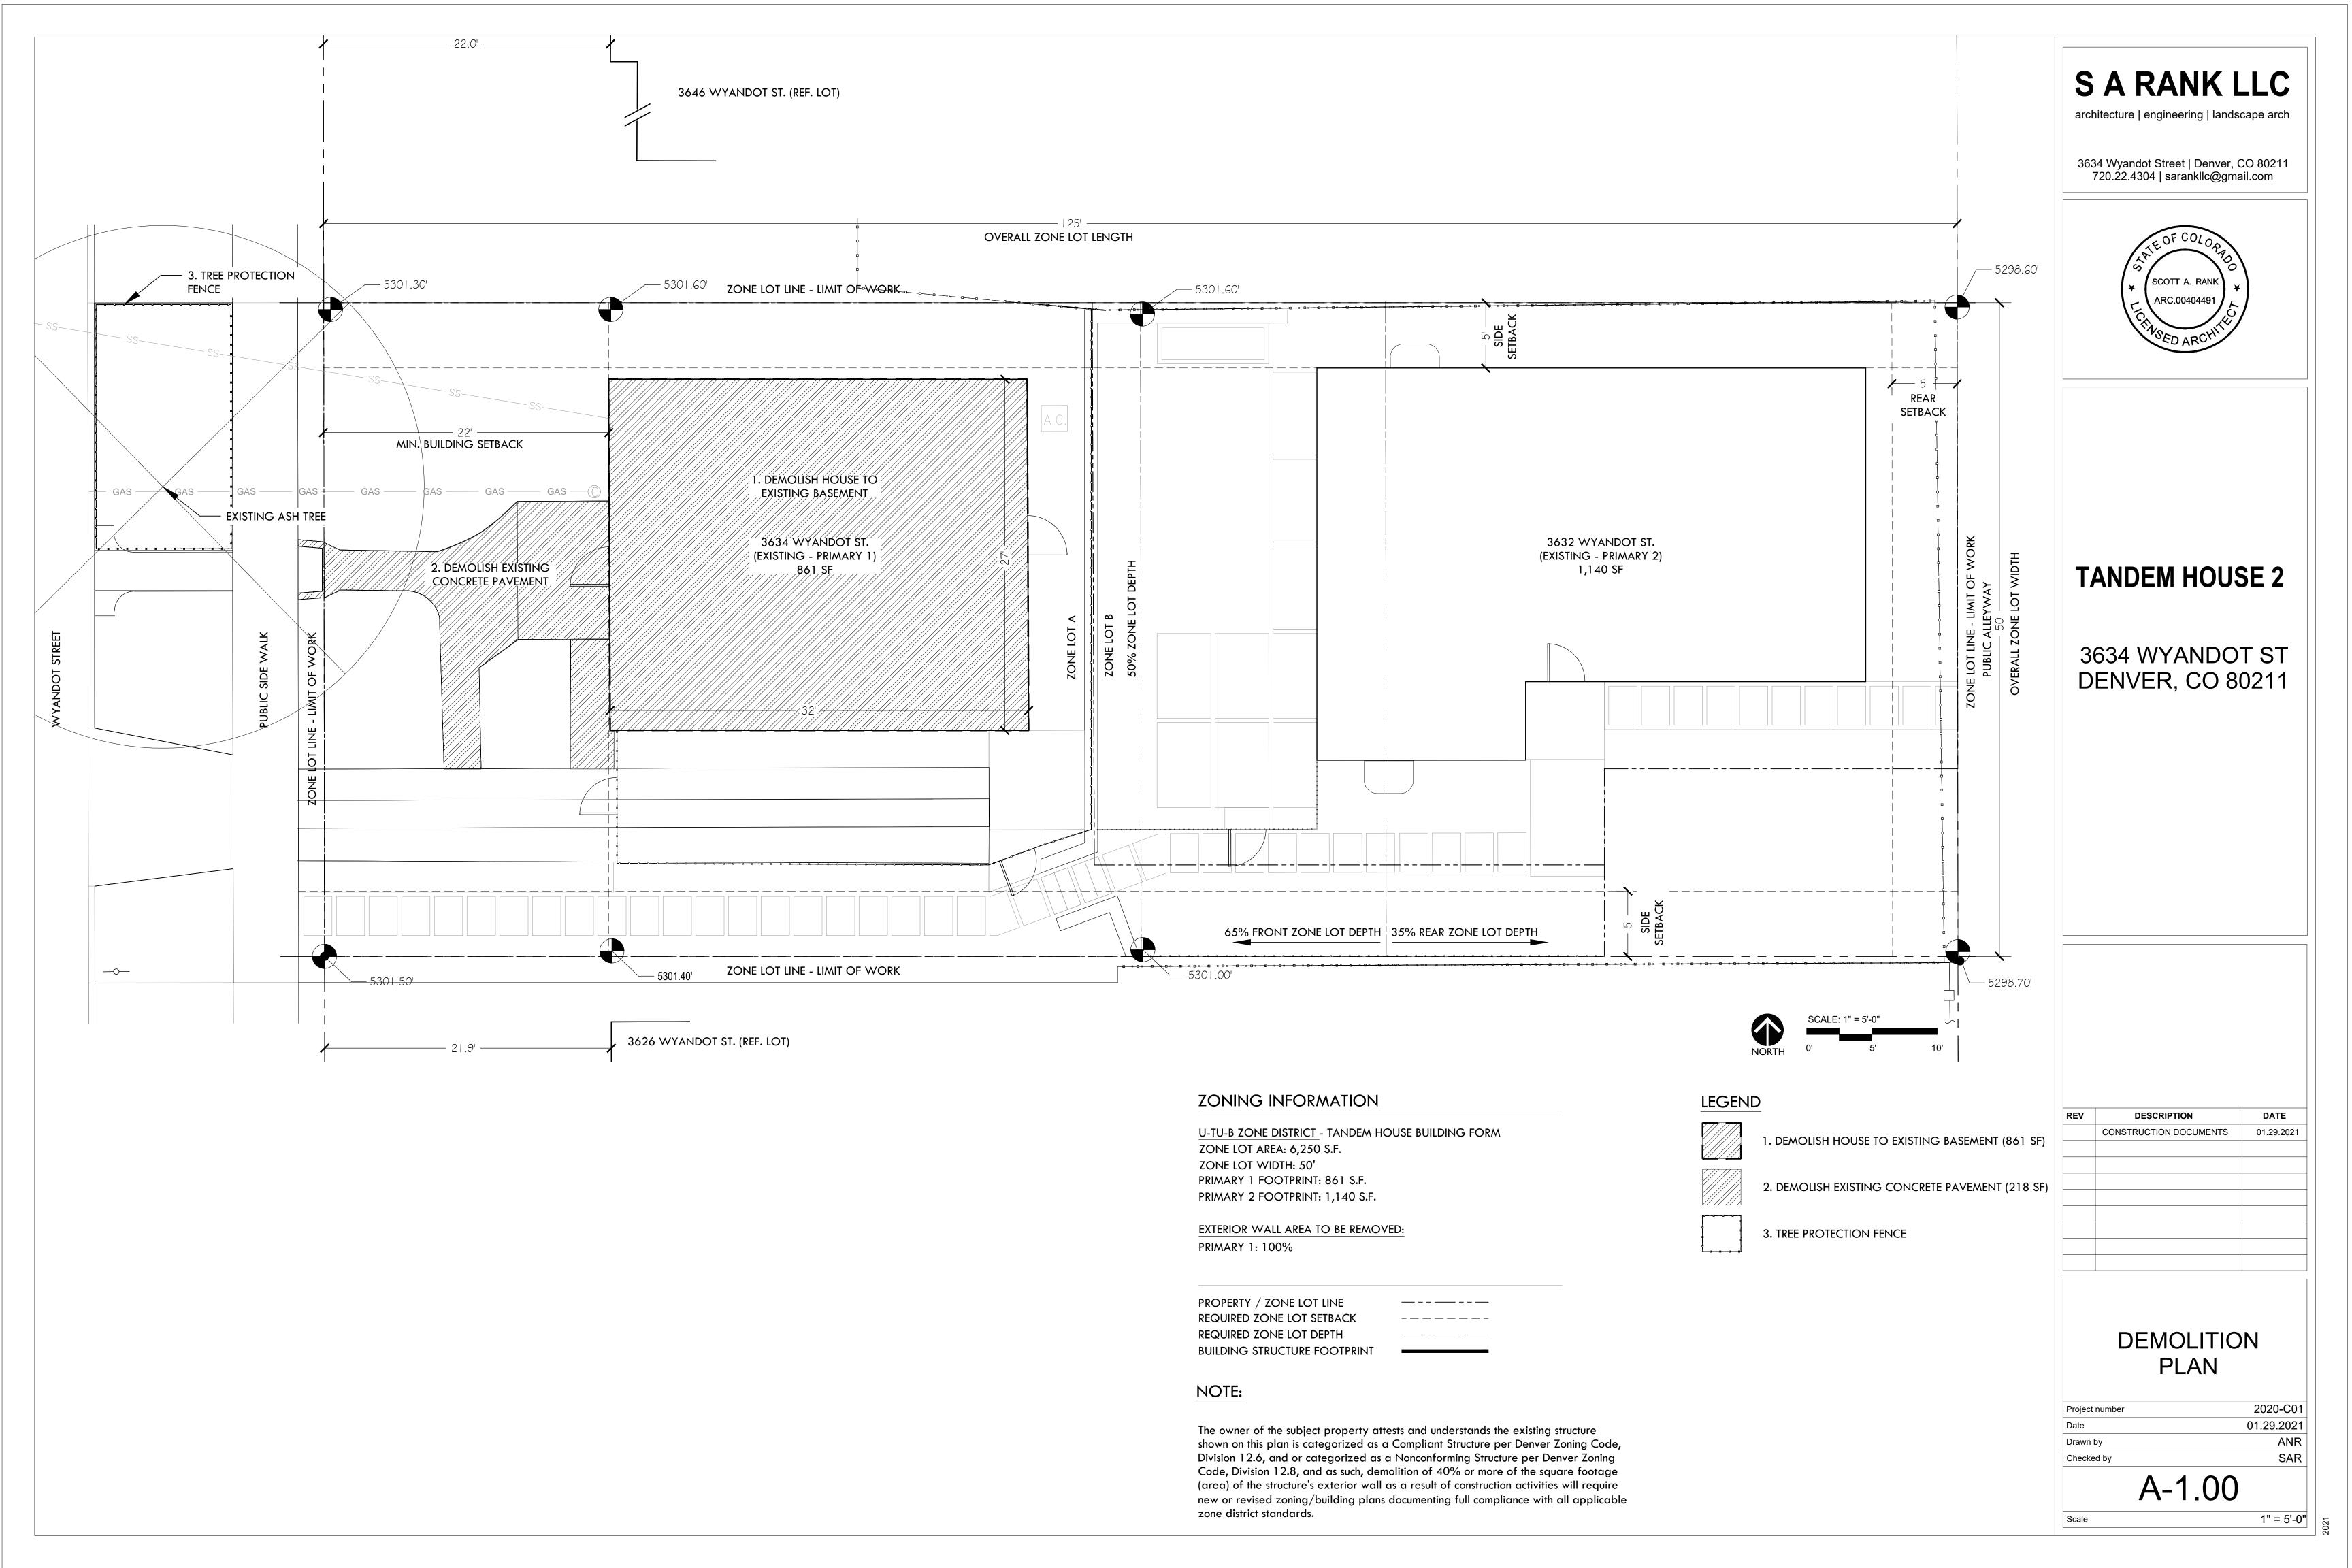

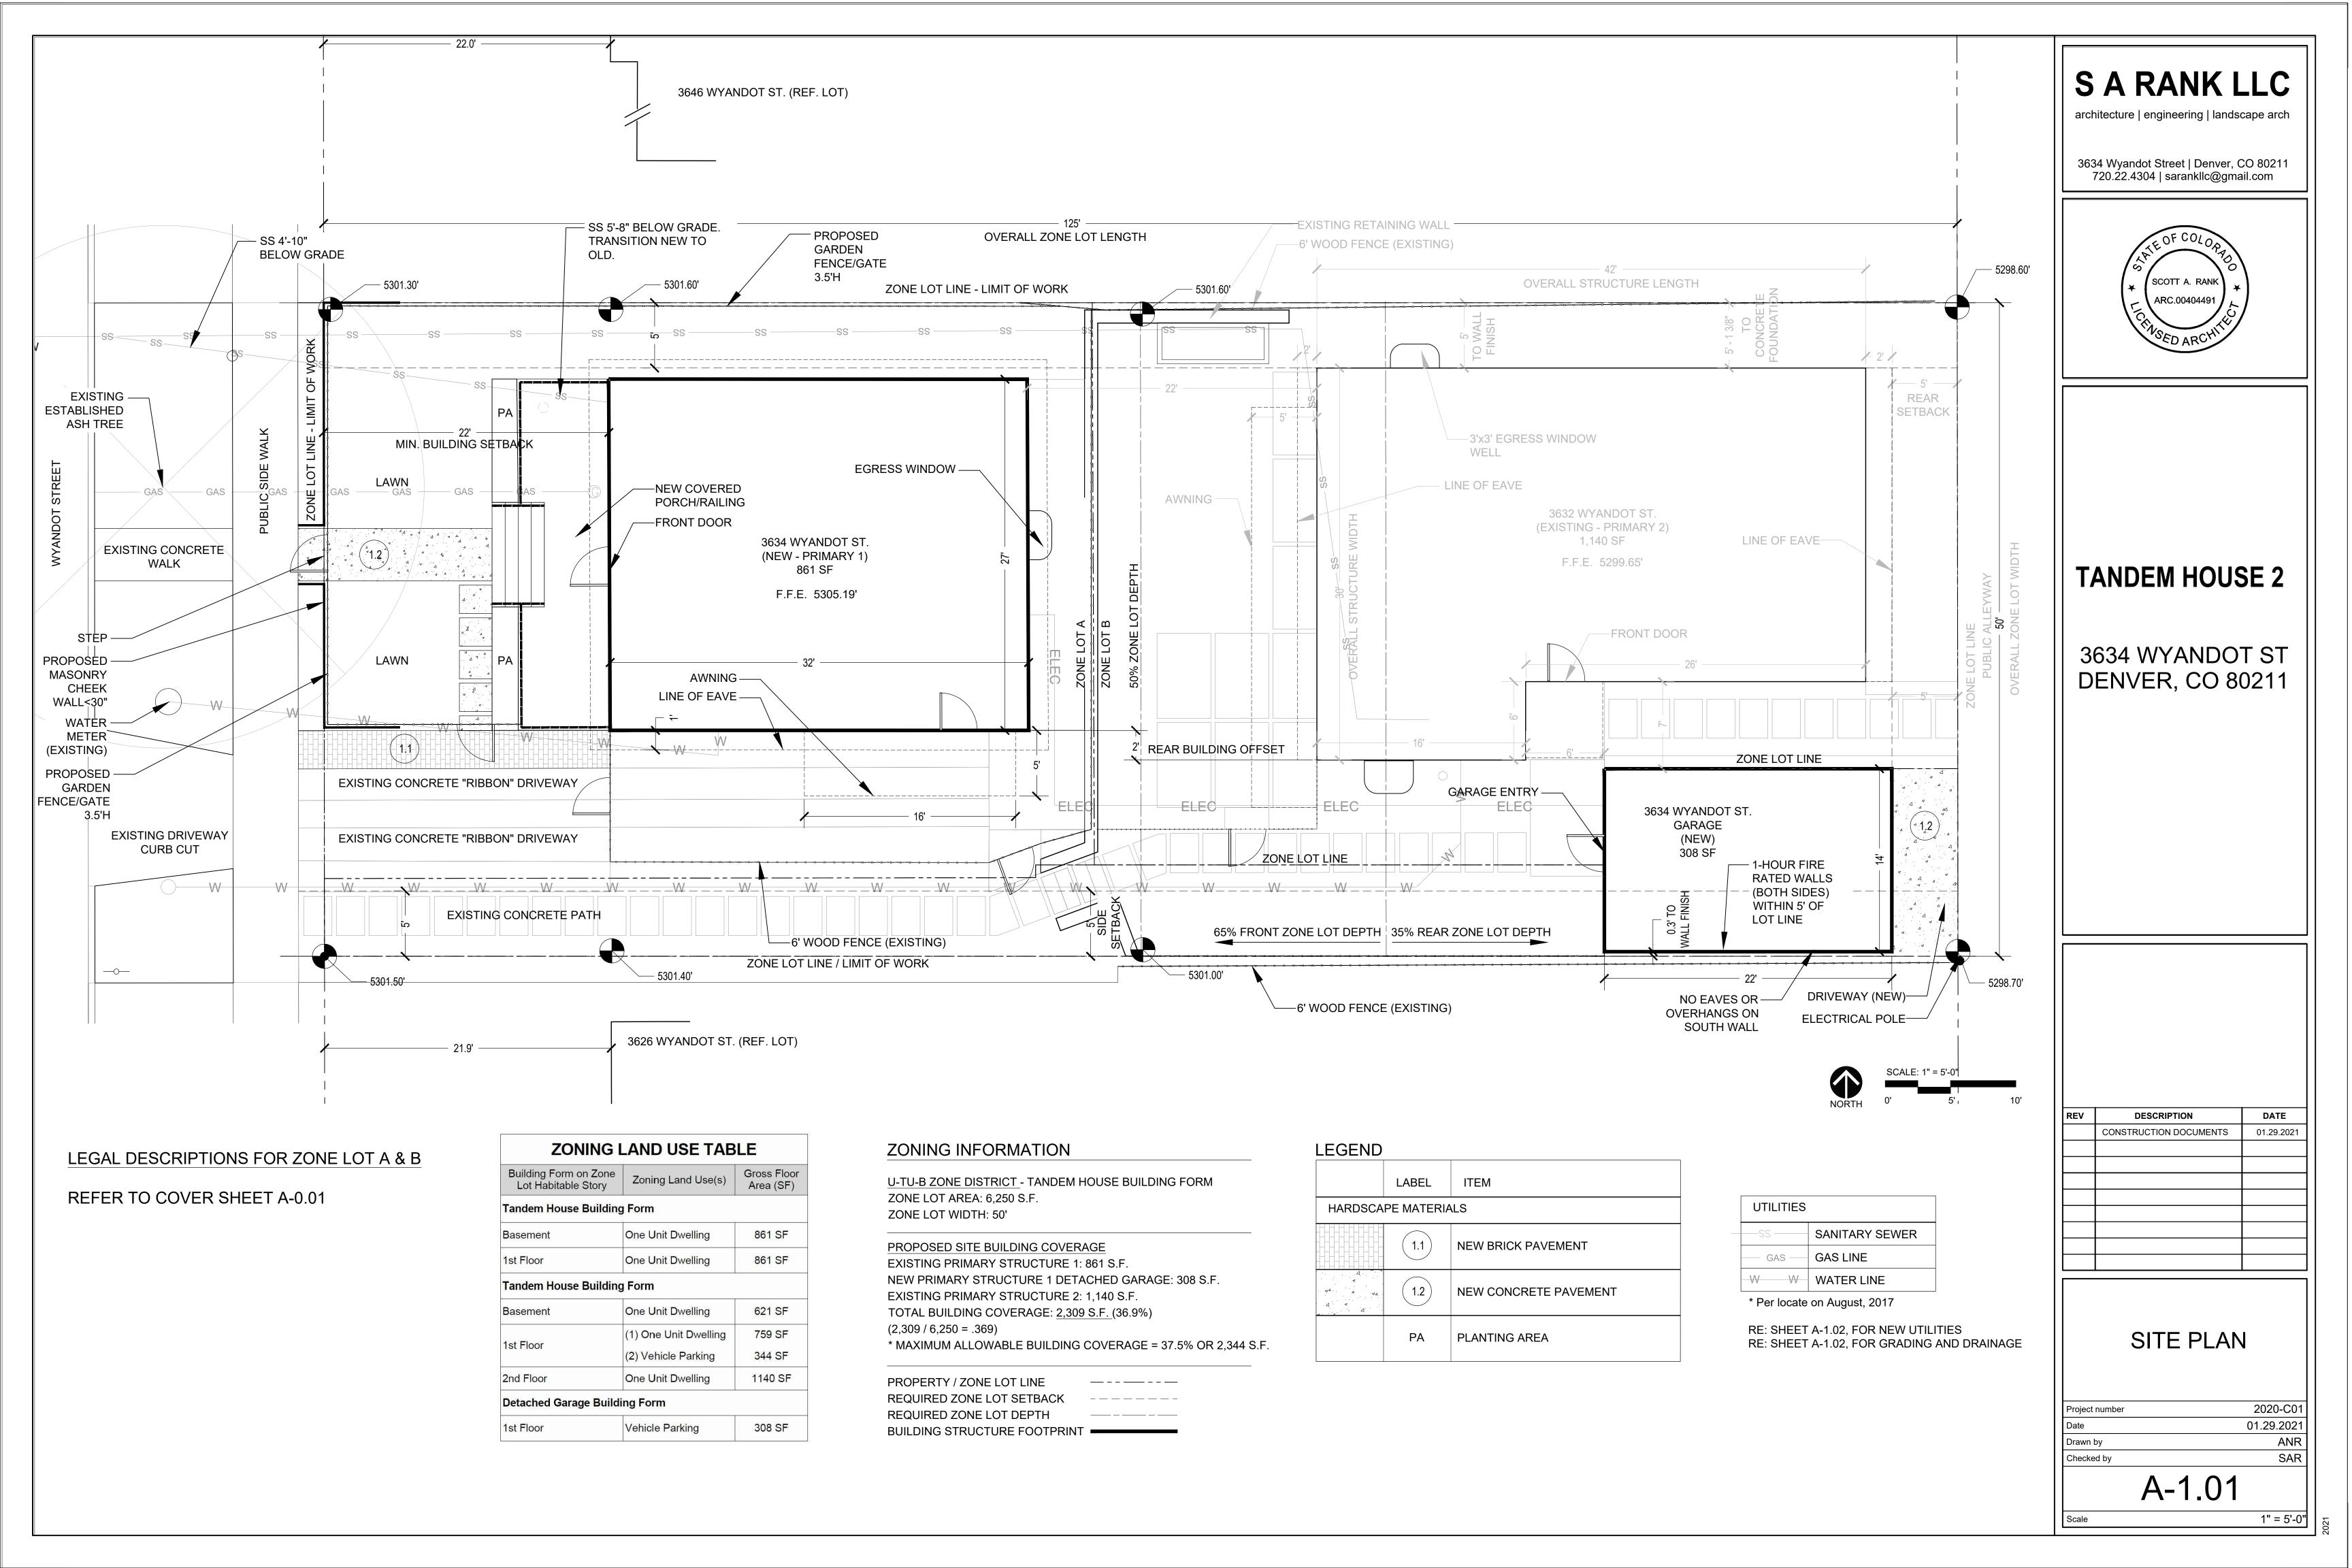

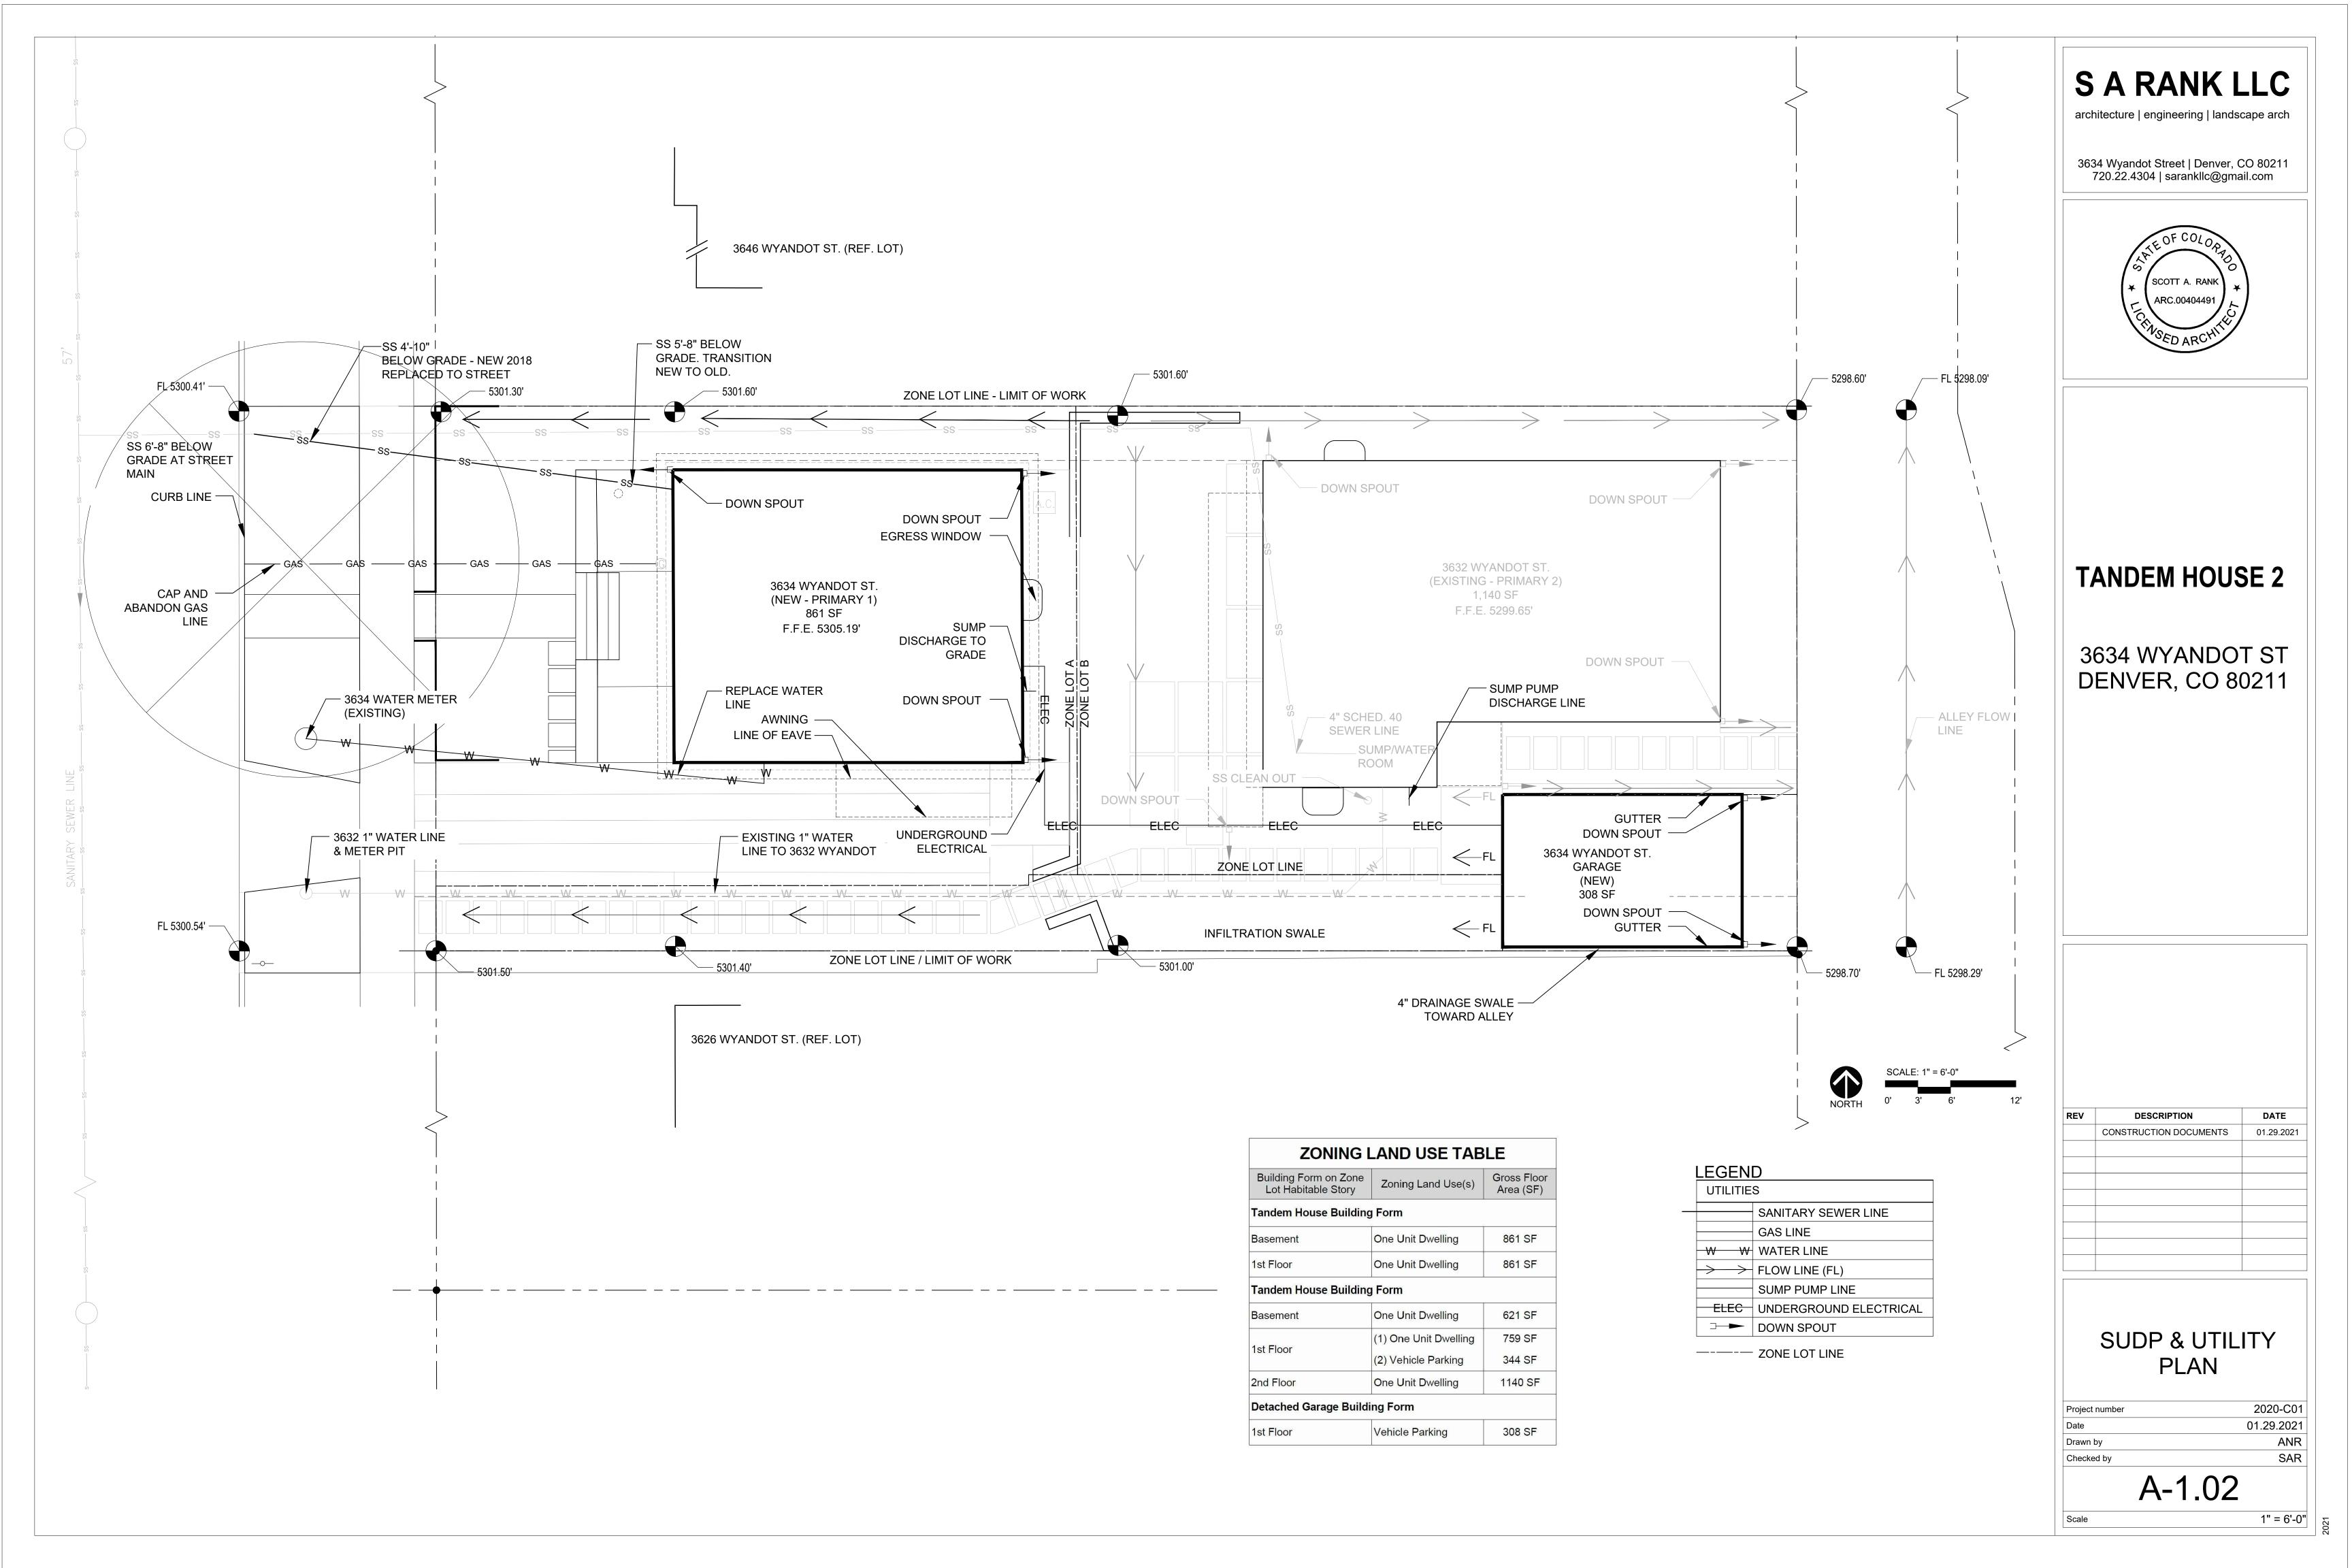



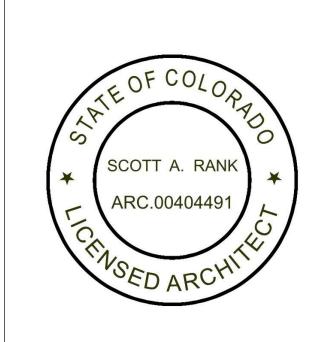



Tandem House 2


3634 WYANDOT ST DENVER, CO 80211

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	CONSTRUCTION DOCUMENTS	01.29.2021



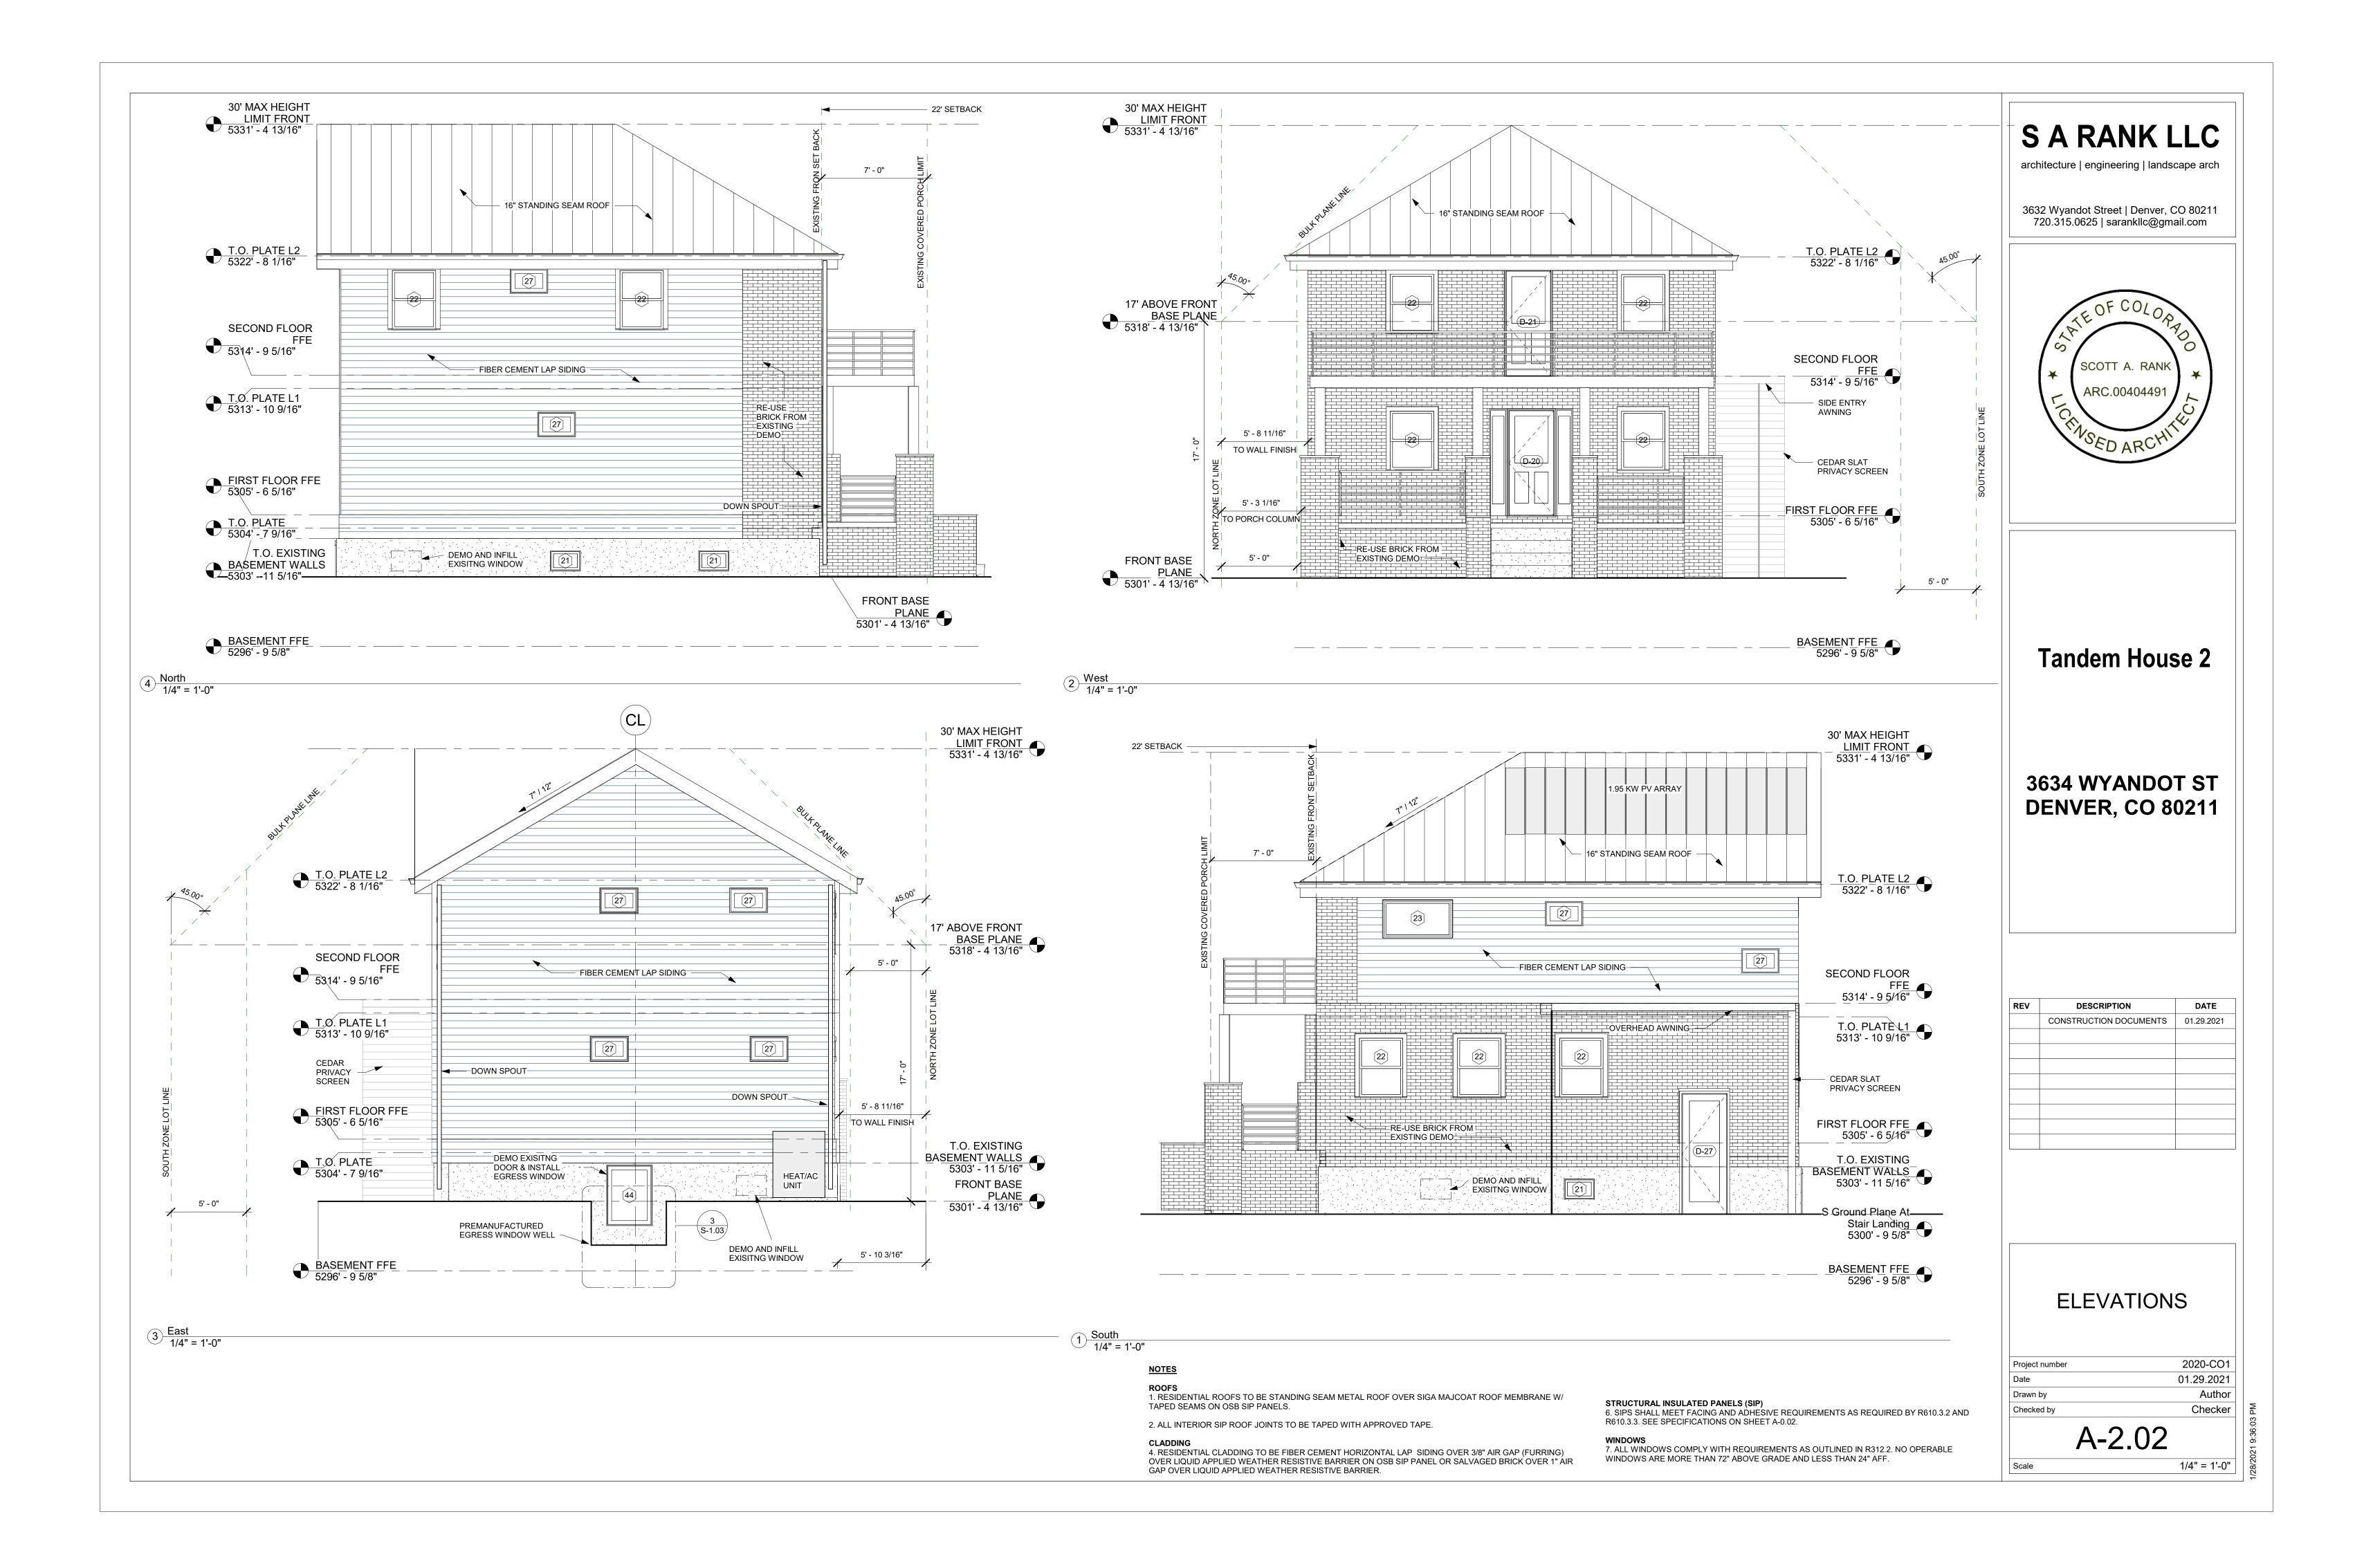


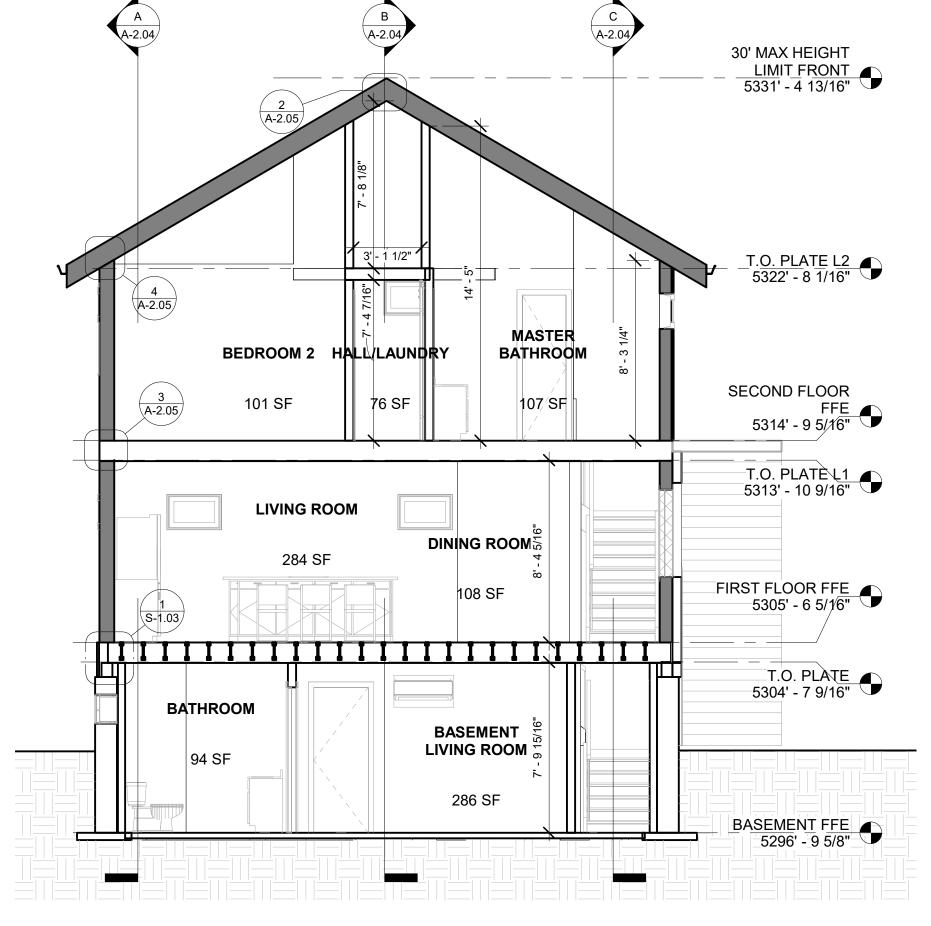

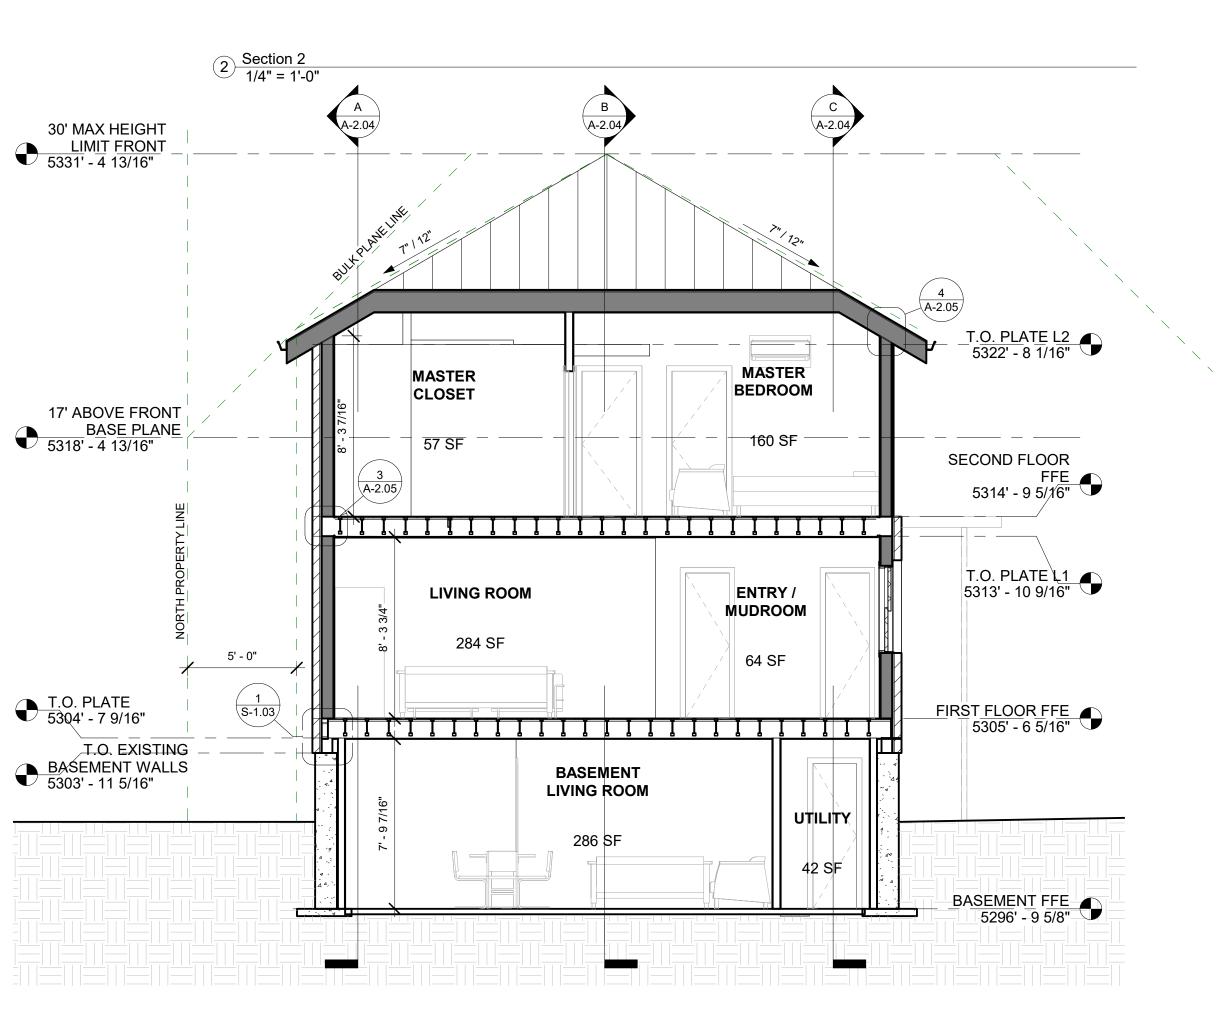



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Tandem House 2

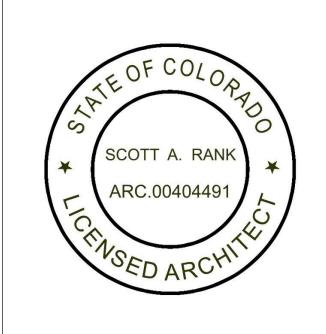3634 WYANDOT ST DENVER, CO 80211

REV	DESCRIPTION	DATE
	CONSTRUCTION DOCUMENTS	01.29.2021

 SECTIONS

 Project number
 2020-C01

 Date
 01.29.2021

 Drawn by
 Author

 Checked by
 Checker

 A-2.03

 Scale
 1/4" = 1'-0"

T.O. PLATE L2 5322' - 8 1/16" ||EHALL/LAUNDRY || ATHROOM BEDROOM 3 SECOND FLOOR 107 SF FFE 5314' - 9 5/16" T.O. PLATE L1 5313' - 10 9/16" **KITCHEN** DINING ROOM 144 SF FIRST FLOOR FFE 5305' - 6 5/1/6" 108 SF T.O. PLATE 5304' - 7 9/16" BEDROOM 4 **BATHROOM** 150 SF BASEMENT FFE 5296' - 9 5/8"

ERV LOFT -CONDITIONED SPACE

1. JOIST PROFILES, WHERE SHOWN, ARE GRAPHIC REPRESENTATIONS ONLY. REFER TO STRUCTURAL FRAMING PLANS FOR SIZING AND SPACING.

30' MAX HEIGHT


LIMIT FRONT 5331' - 4 13/16"

NOTES:


3 Section 3 1/4" = 1'-0" 4 A-2.05


1 Section 1 1/4" = 1'-0"

NOTES: 1. JOIST PROFILES, WHERE SHOWN, ARE GRAPHIC REPRESENTATIONS ONLY. REFER TO STRUCTURAL FRAMING PLANS FOR SIZING AND SPACING.

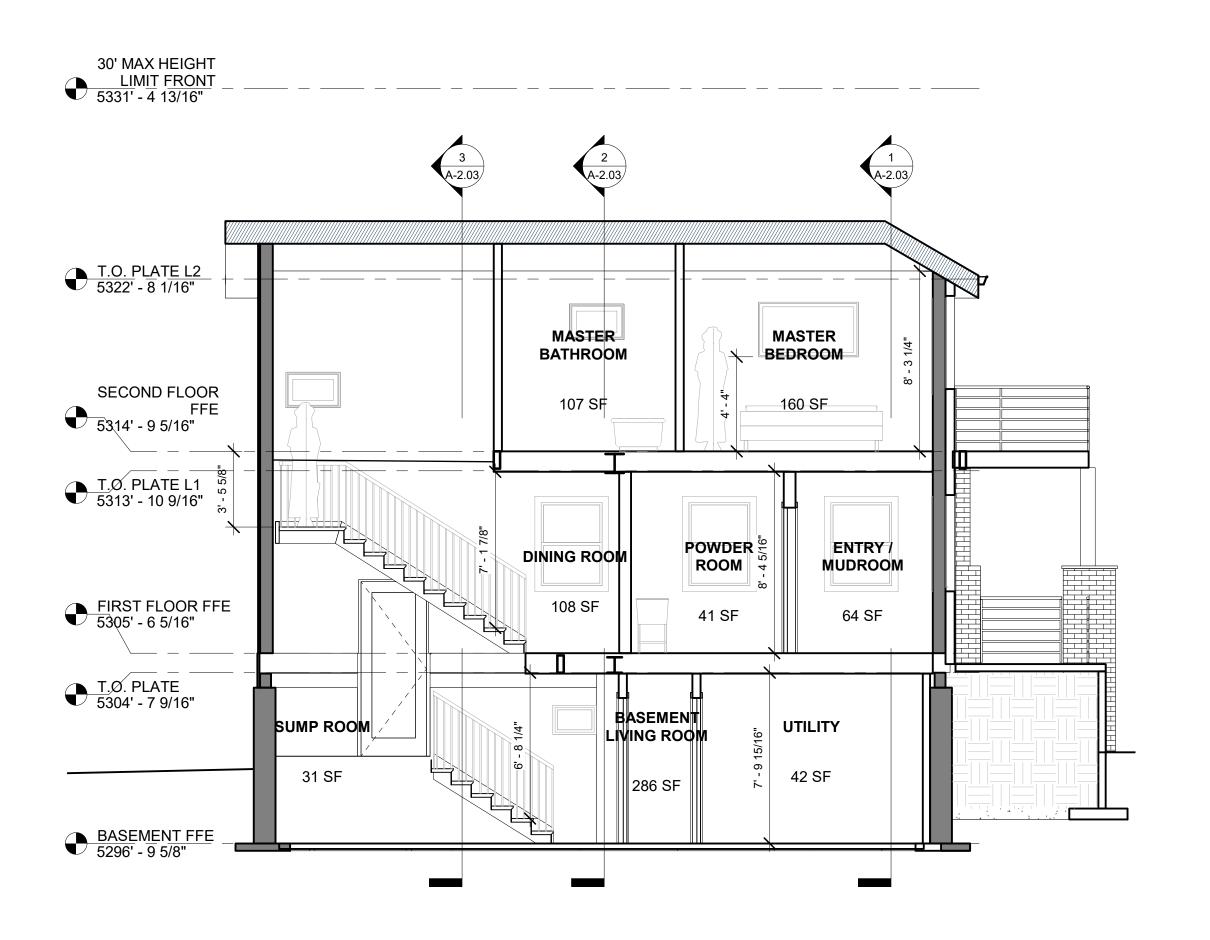


C Section C 1/4" = 1'-0"

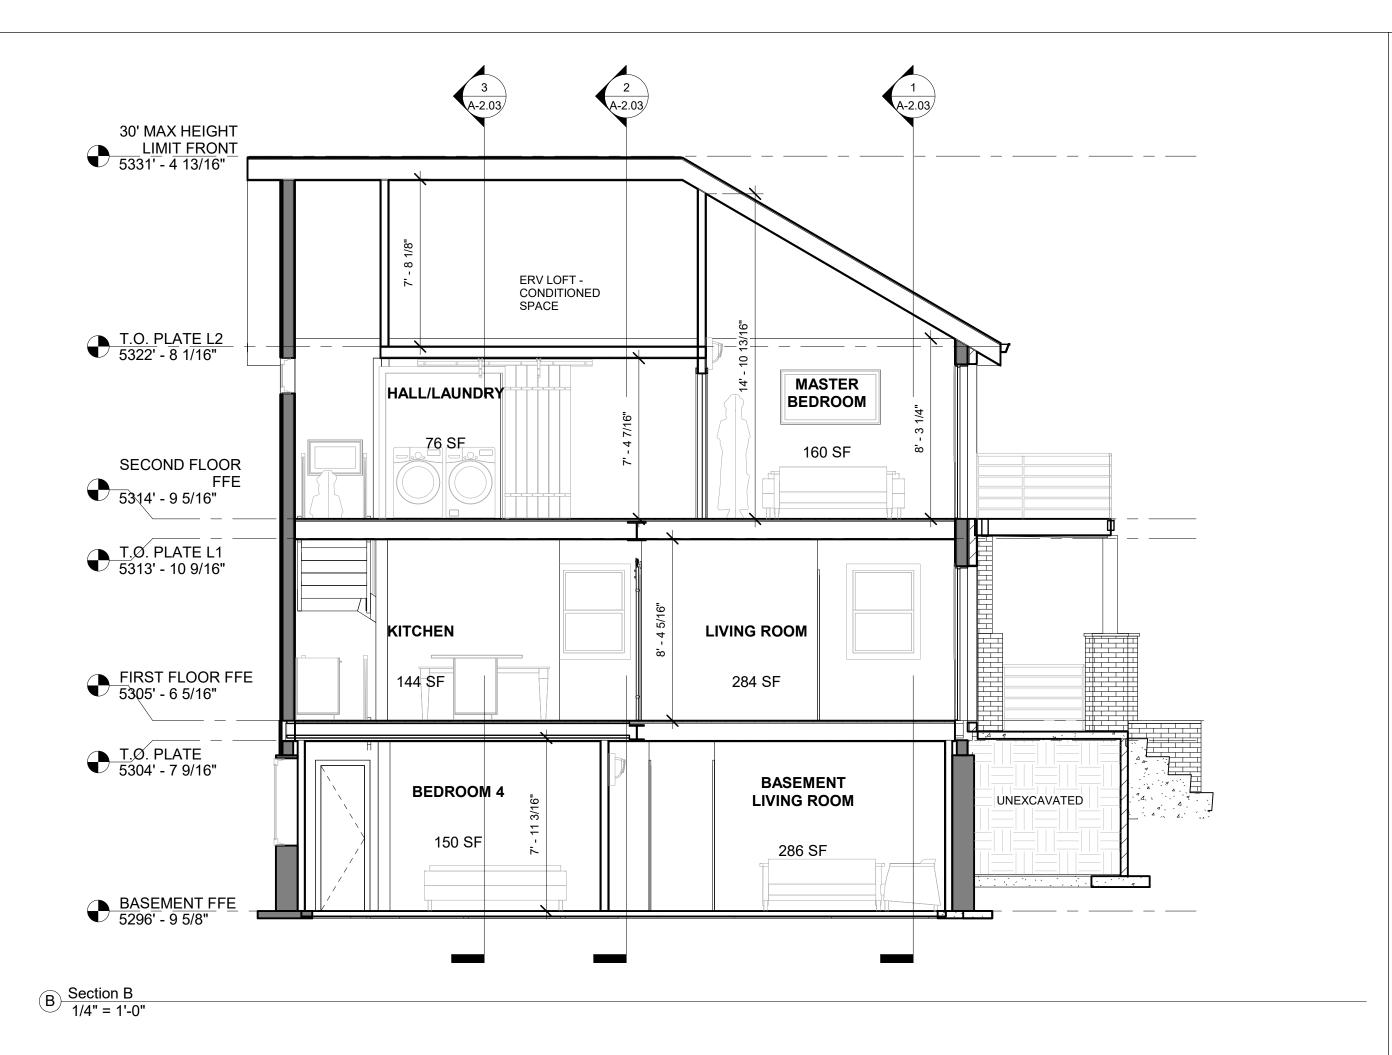

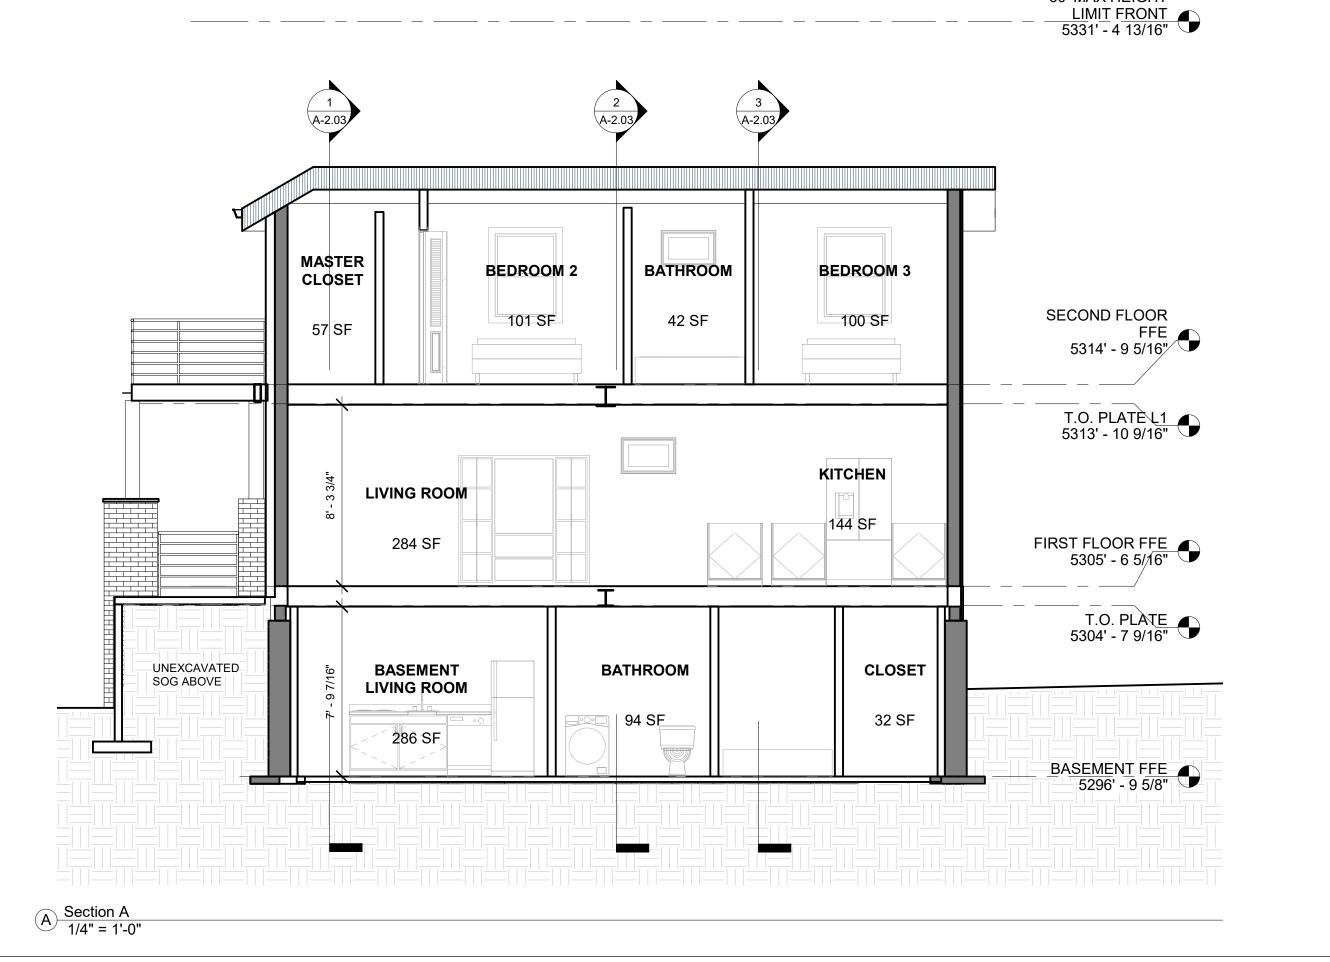



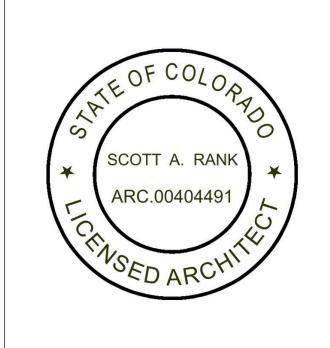


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30' MAX HEIGHT


REV	DESCRIPTION	DATE
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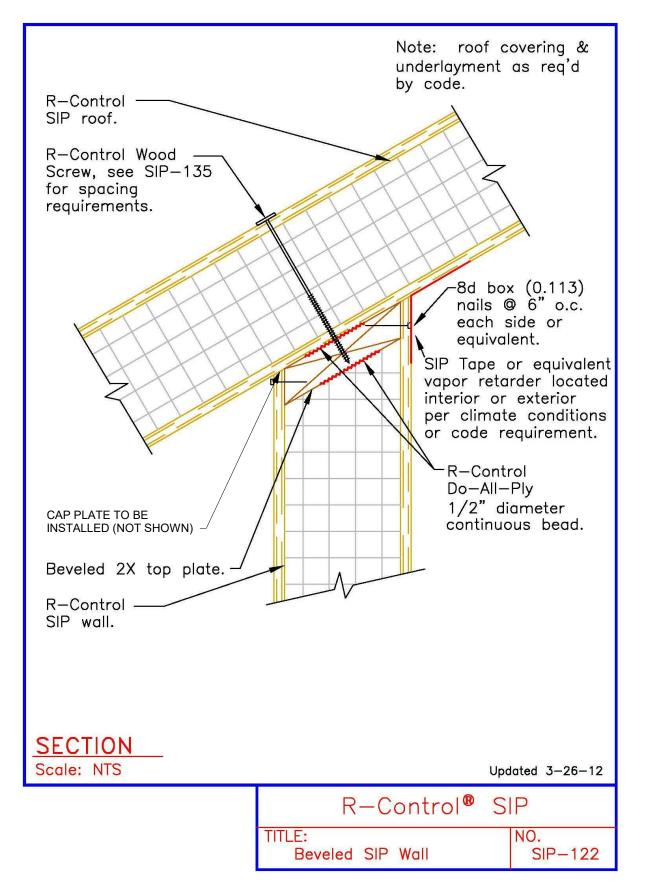


NOTES


1. ALL SIP CONSTRUCTION SHALL BE IN CONFORMANCE WITH IRC SECTION R610 UNLESS OTHERWISE NOTED.

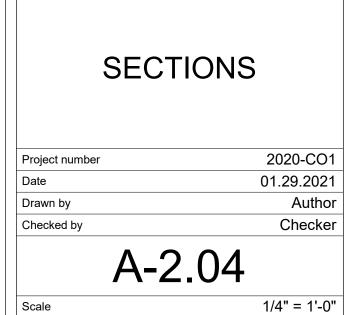
2. A DOUBLE TOP PLATE (TOP PLATE PLUS CAP PLATE) SHALL BE PROVIDED AT ALL WALL TO FLOOR AND WALL TO ROOF CONNECTIONS PER R610.5.1.



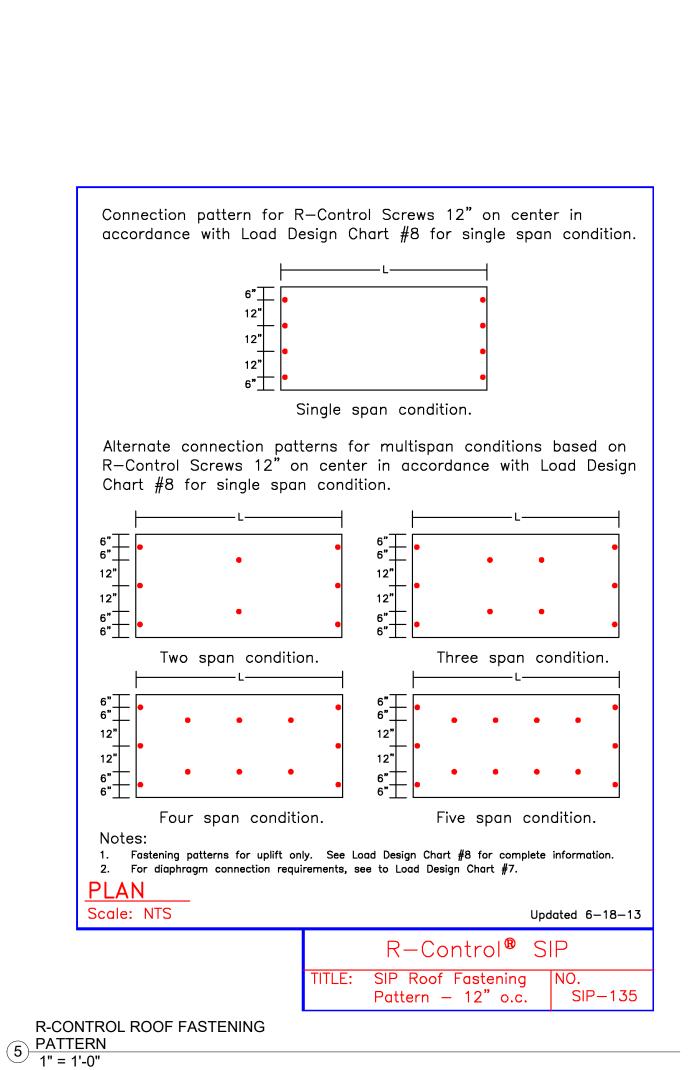


4 R-CONTROL BEVELED WALL TO ROOF 1" = 1'-0"

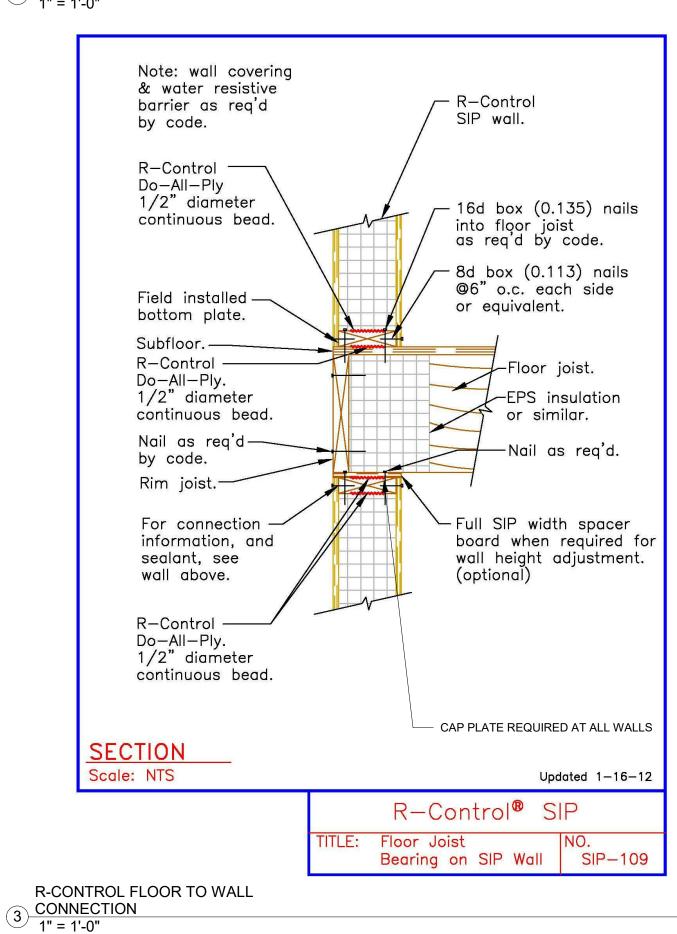

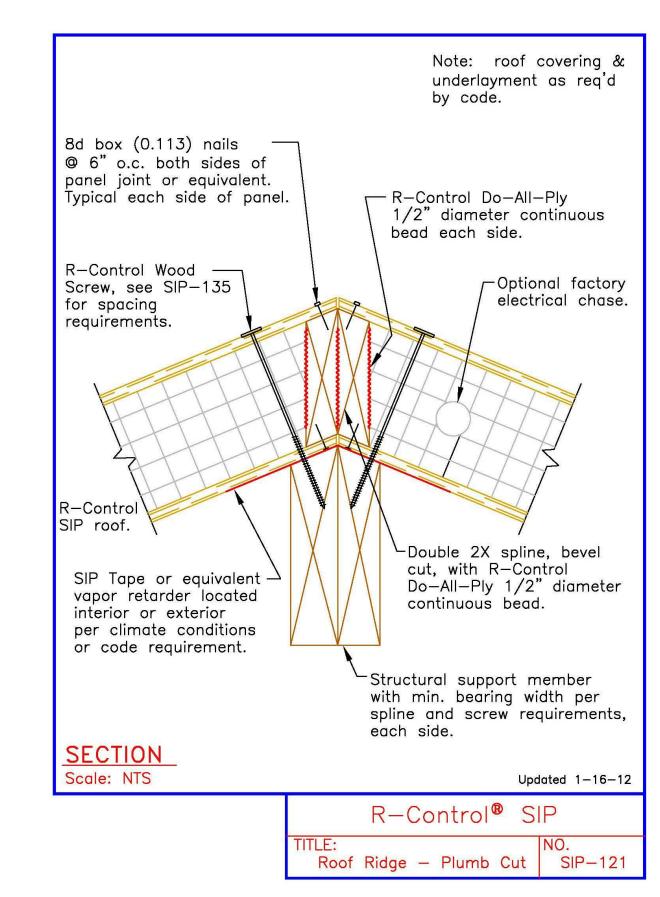

2 R-CONTROL RIDGE BEAM DETAIL 1" = 1'-0"

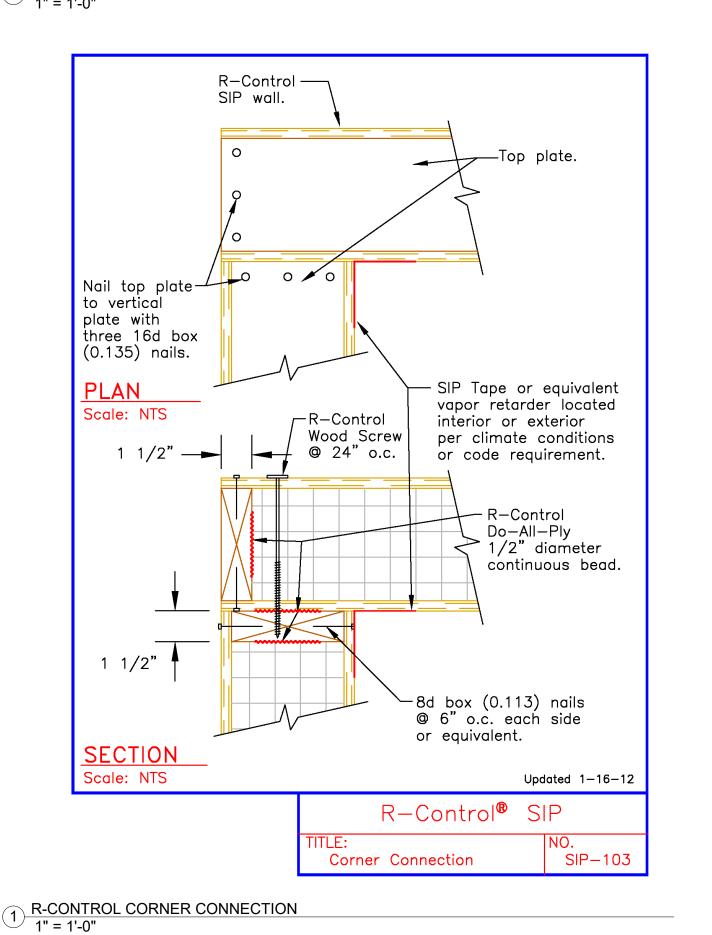

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Tandem House 2


3634 WYANDOT ST DENVER, CO 80211

REV	DESCRIPTION	DATE
	CONSTRUCTION DOCUMENTS	01.29.202

SIP DE	ETAILS
Project number	2020-0
Date	01.29.2
Drawn by	Aut
Checked by	Chec

Scale

Author Checker

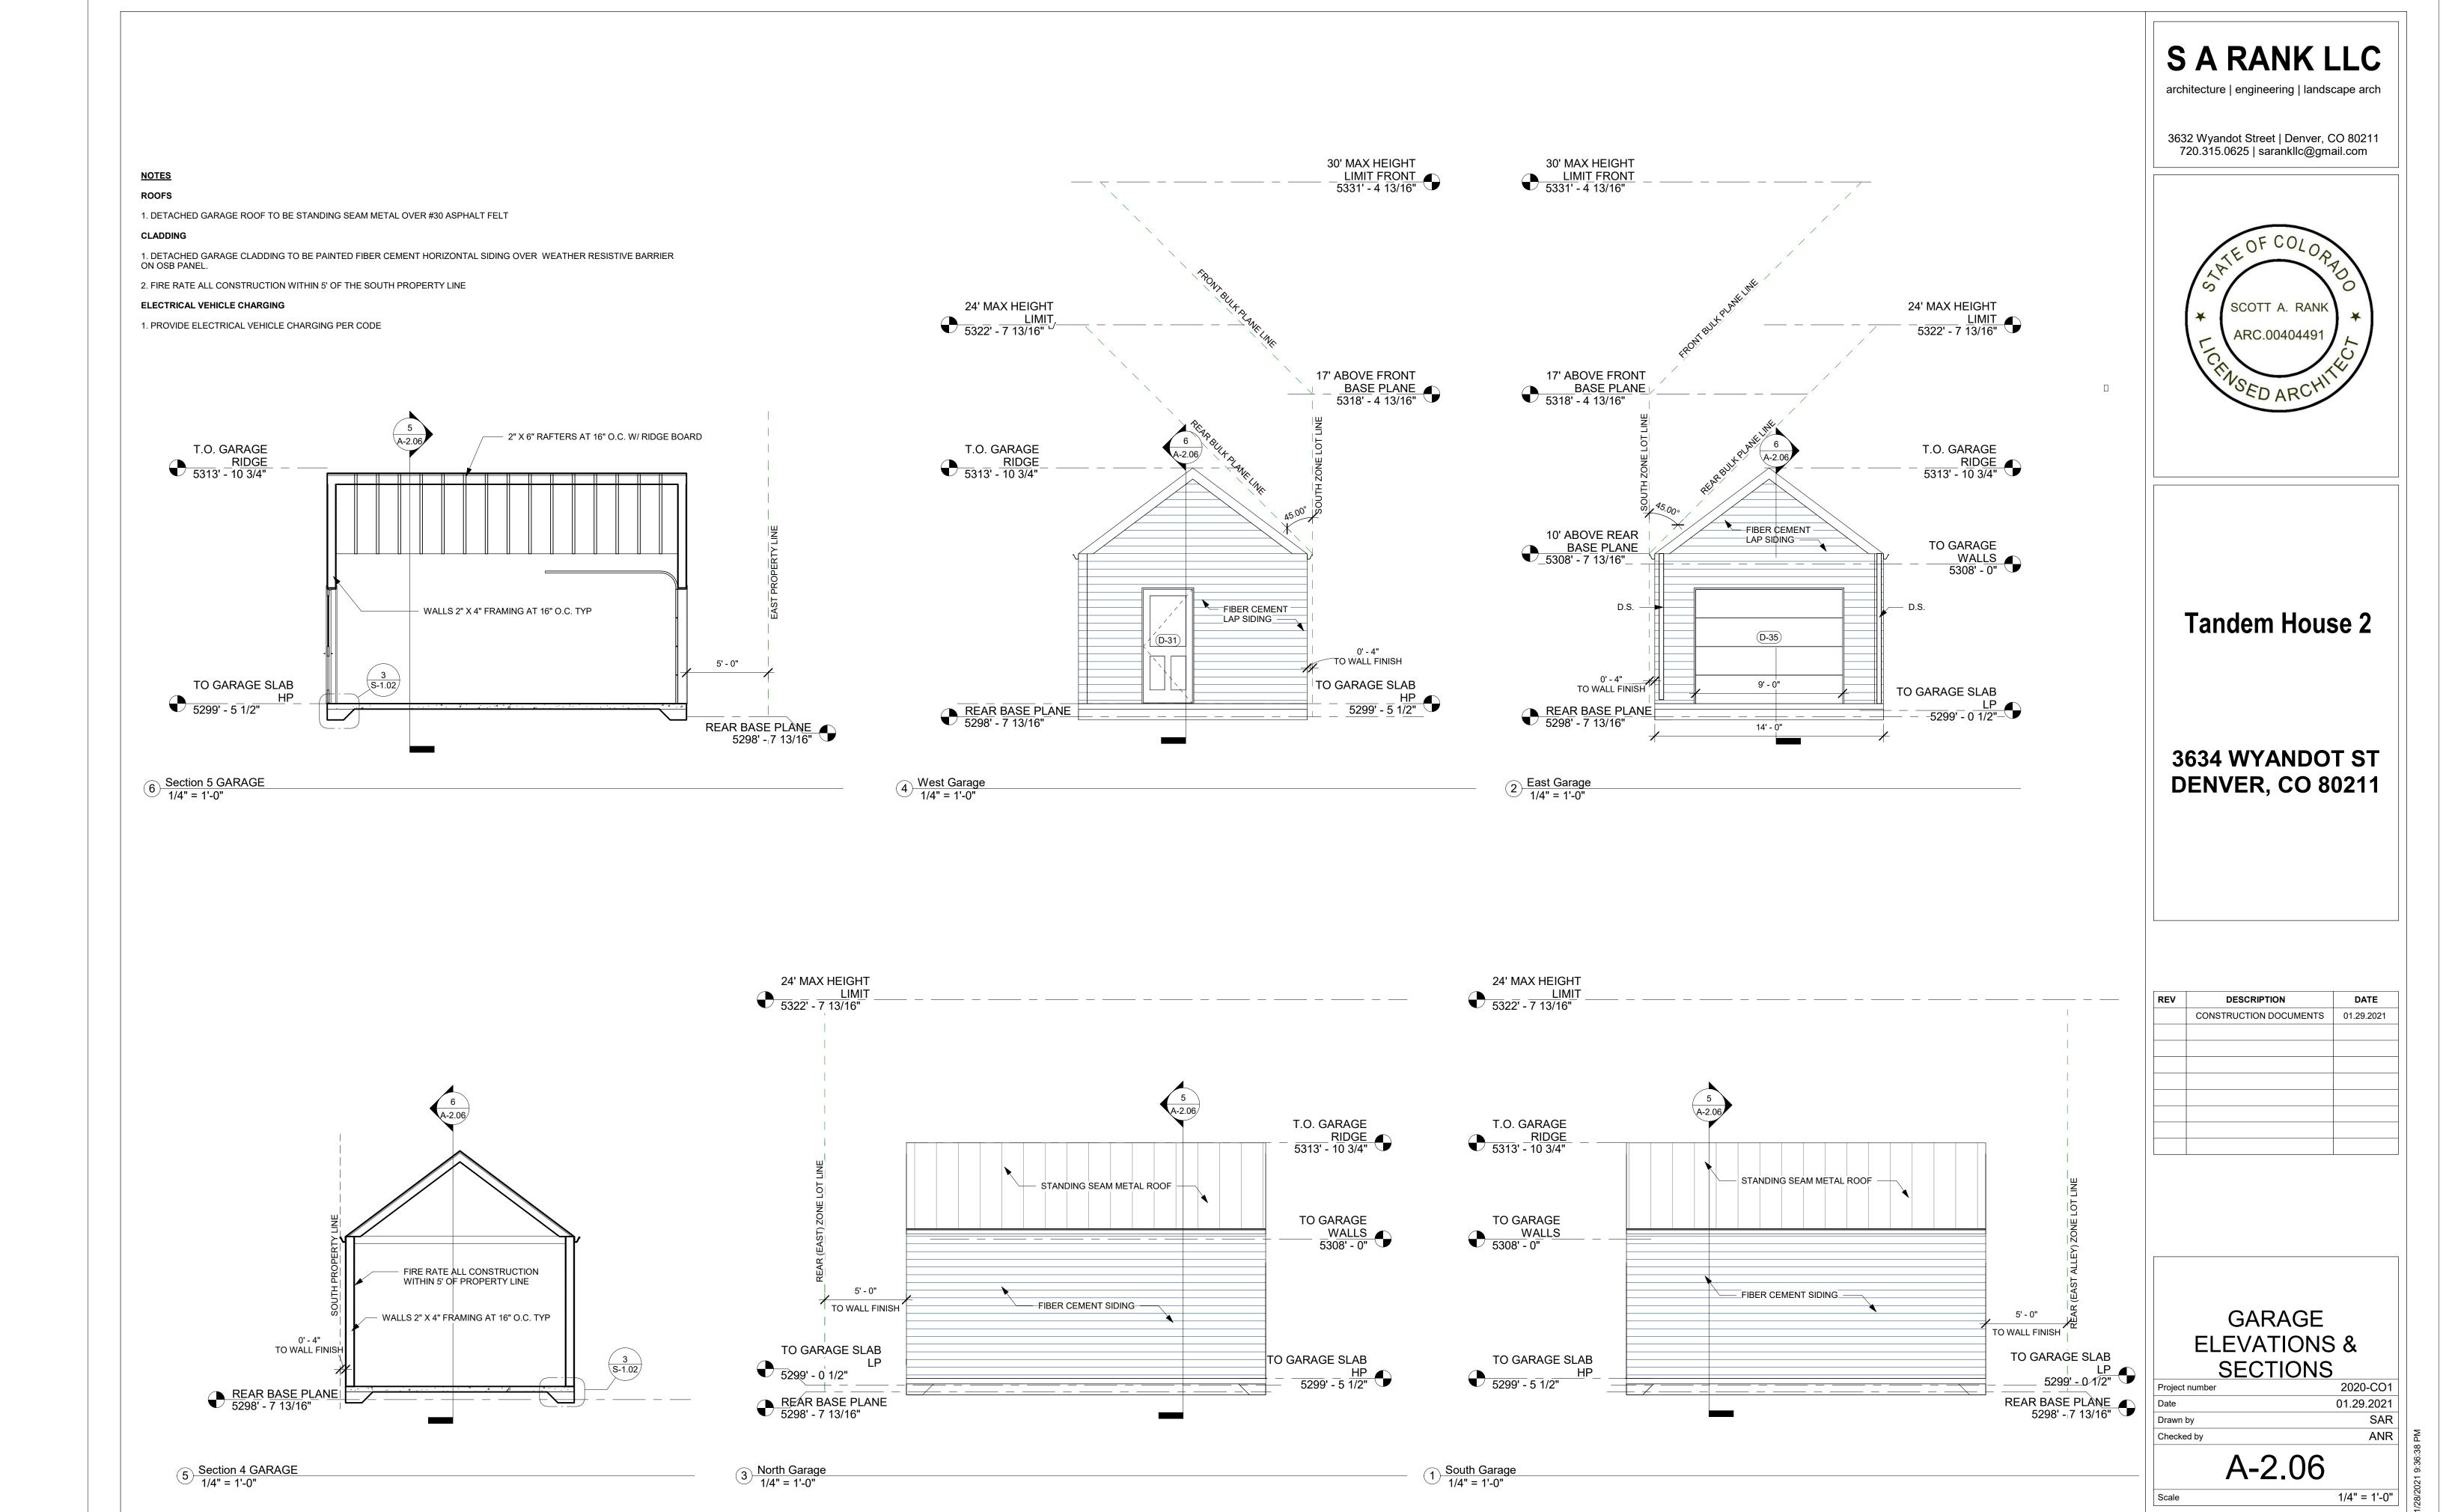

ELECTRICAL NOTES:

- ELECTRICAL CONTRACTOR TO VERIFY ALL LOAD REQUIREMENTS INCLUDING BUT NOT LIMITED TO THE FOLLOWING:
 A. SOLAR PANEL INSTALLATION
 B. ELECTRIC CHARGING STATION

 - C. APPLIANCES
 - D. HVAC EQUIPMENT E. ELECTRIC HOT WATER HEATERS
- 2. CONTRACTOR TO COORDINATE LOCATIONS OF HVAC EQUIPMENT WITH MECHANICAL
- 3. CONTRACTOR TO VERIFY TYPE AND LOCATIONS OF ALL LIGHTING FIXTURES WITH OWNER
- 4. BASEMENT LIVING ROOM LIGHTING TO COMPLY WITH IRC SECTION R303.1 EXCEPTION 2; LIGHTING SHALL PROVIDE A MINIMUM AVERAGE ILLUMINON OF 6 FOOTCANDLES (65 LUX) AT A HEAIGHT OF 30" ABOVE
- 5.**GARAGE EV CHARGING**; CIRCUIT BREAKERS OR CIRCUIT BREAKER SPACES RESERVED FOR THE EV CAPABLE, READY AND EVSE INSTALLED SPACES SHALL BE IDENTIFIED ON THE PANELBOARD DIRECTORY. ALL EMPTY CONDUITS FOR THE EV CAPABLE SPACES SHALL BE IDENTIFIED AT BOTH THE PANELBOARD AND AT THE TERMINATION POINT AT THE PARKING


SYMBOL	DESCRIPTION
\$	SWITCH
\$3	3 WAY SWITCH
Φ	DUPLEX OUTLET
GFCI	GROUND FAULT OUTLET
-	CEILING LIGHT FIXTURE
\bigcirc	RECESSED CAN LIGHT
K	WALL LIGHT FIXTURE

PENDANT LIGHT

CEILING FAN


ELECTRICAL LEGEND
1/4" = 1'-0"


5 ELECTRICAL GARAGE PLAN 1/4" = 1'-0"

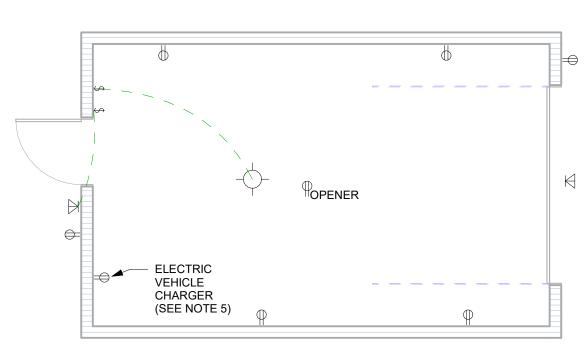




/30 FOOTCANDLES ILLUMINATION REQUIRED

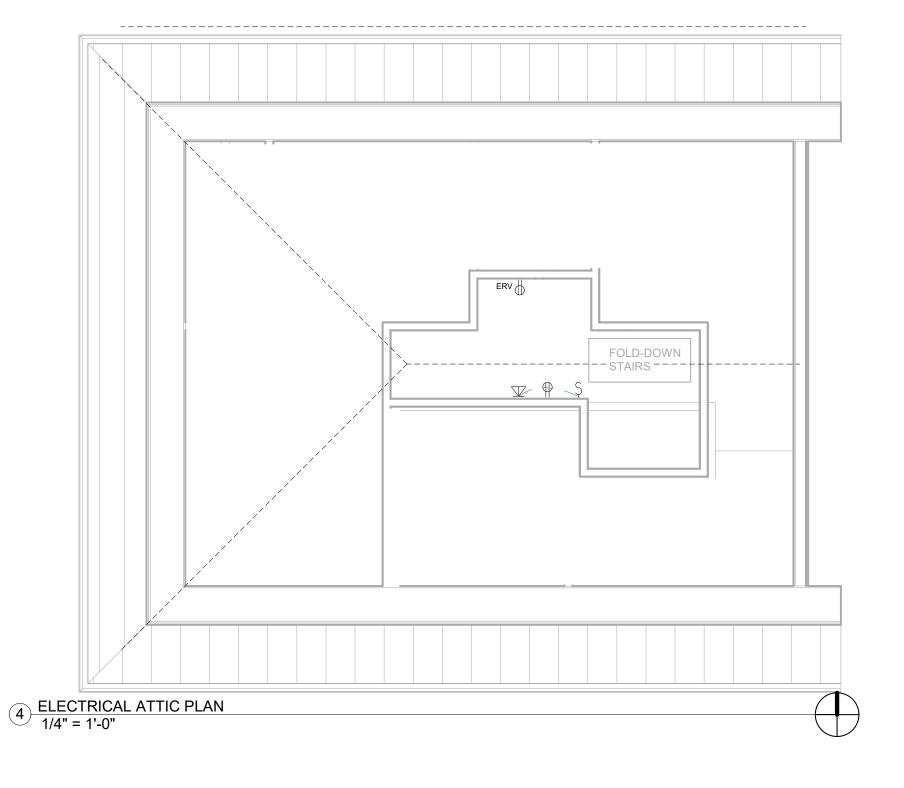

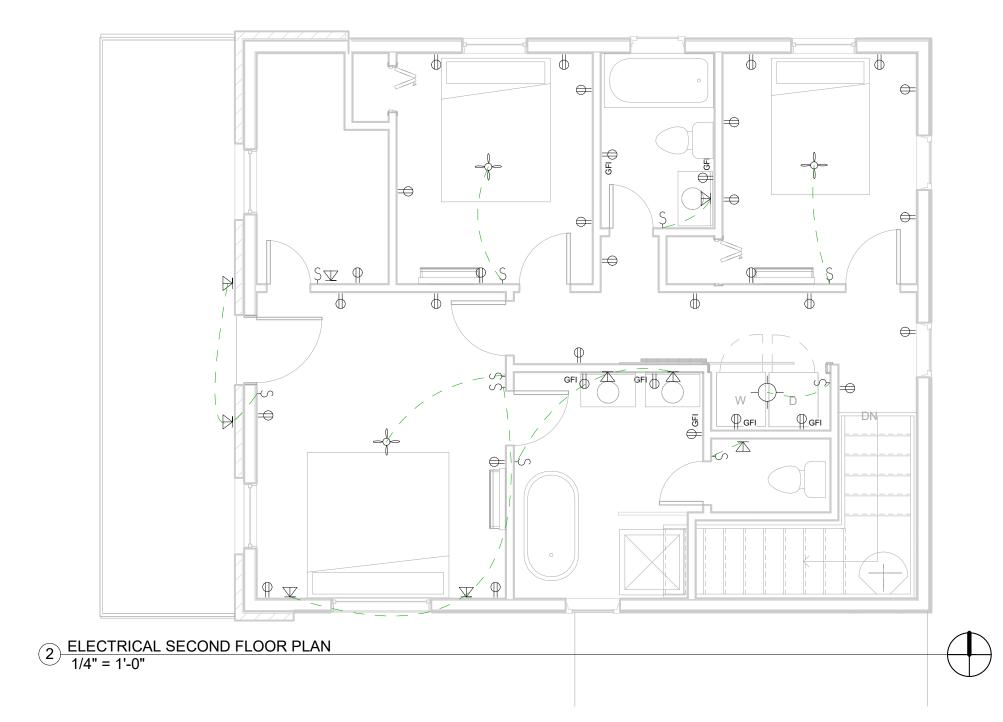

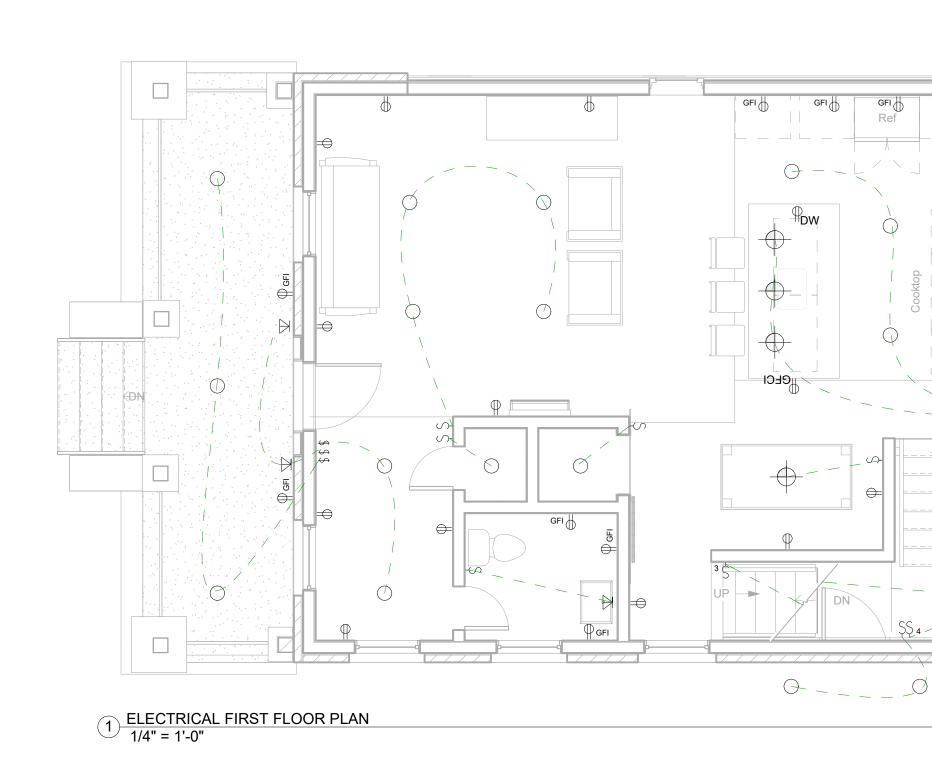

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Tandem House 2


3634 WYANDOT ST DENVER, CO 80211

REV	DESCRIPTION	DATE
	CONSTRUCTION DOCUMENTS	01.29.2021


ELECTRICAL PLANS


2020-CO1 Project number 01.29.2021 Author Checker

E-1.00 1/4" = 1'-0" Scale

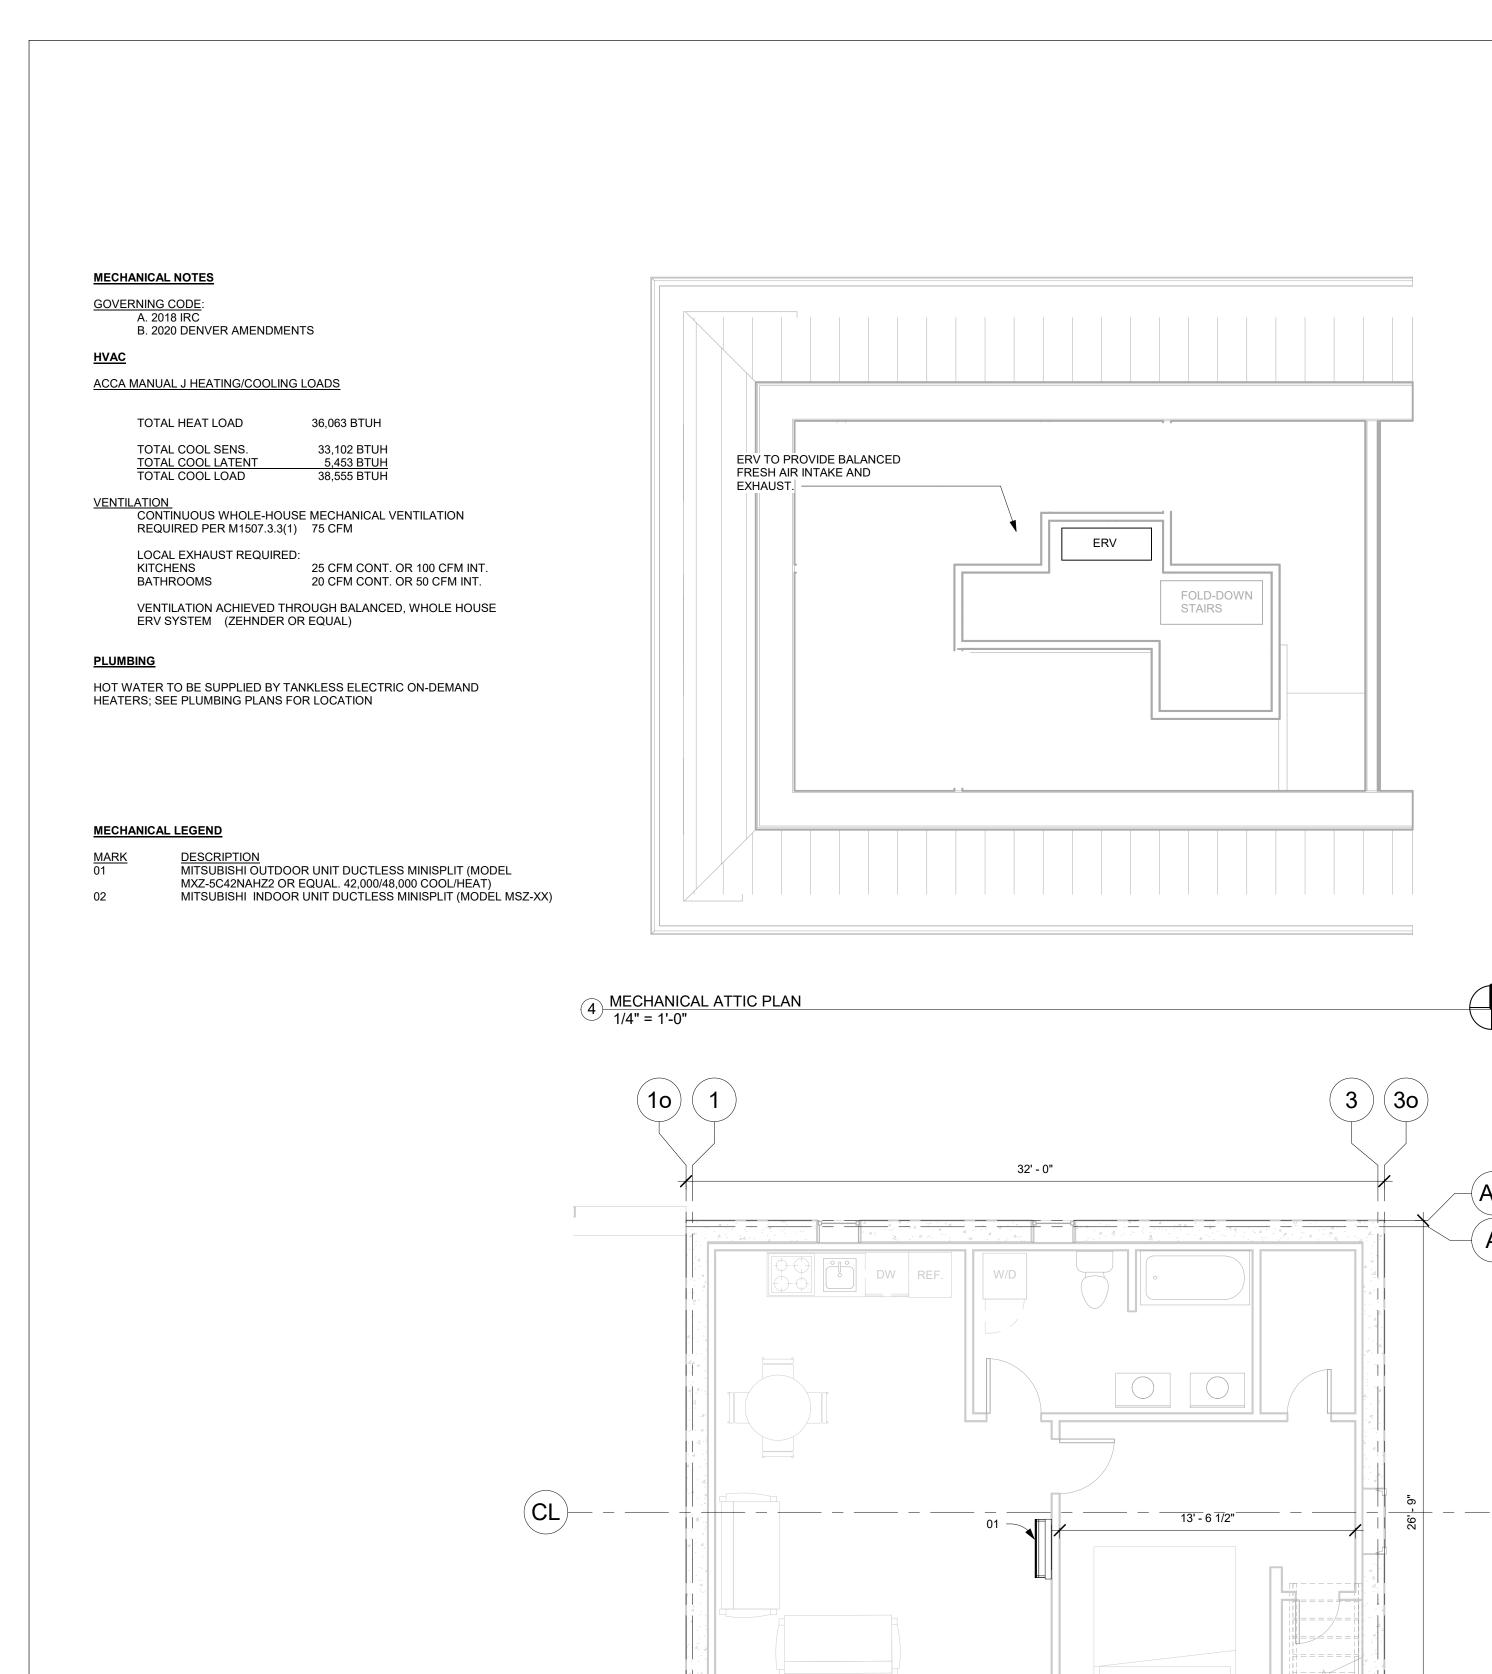

3 MECHANCIAL BASEMENT FLOOR PLAN 1/4" = 1'-0"

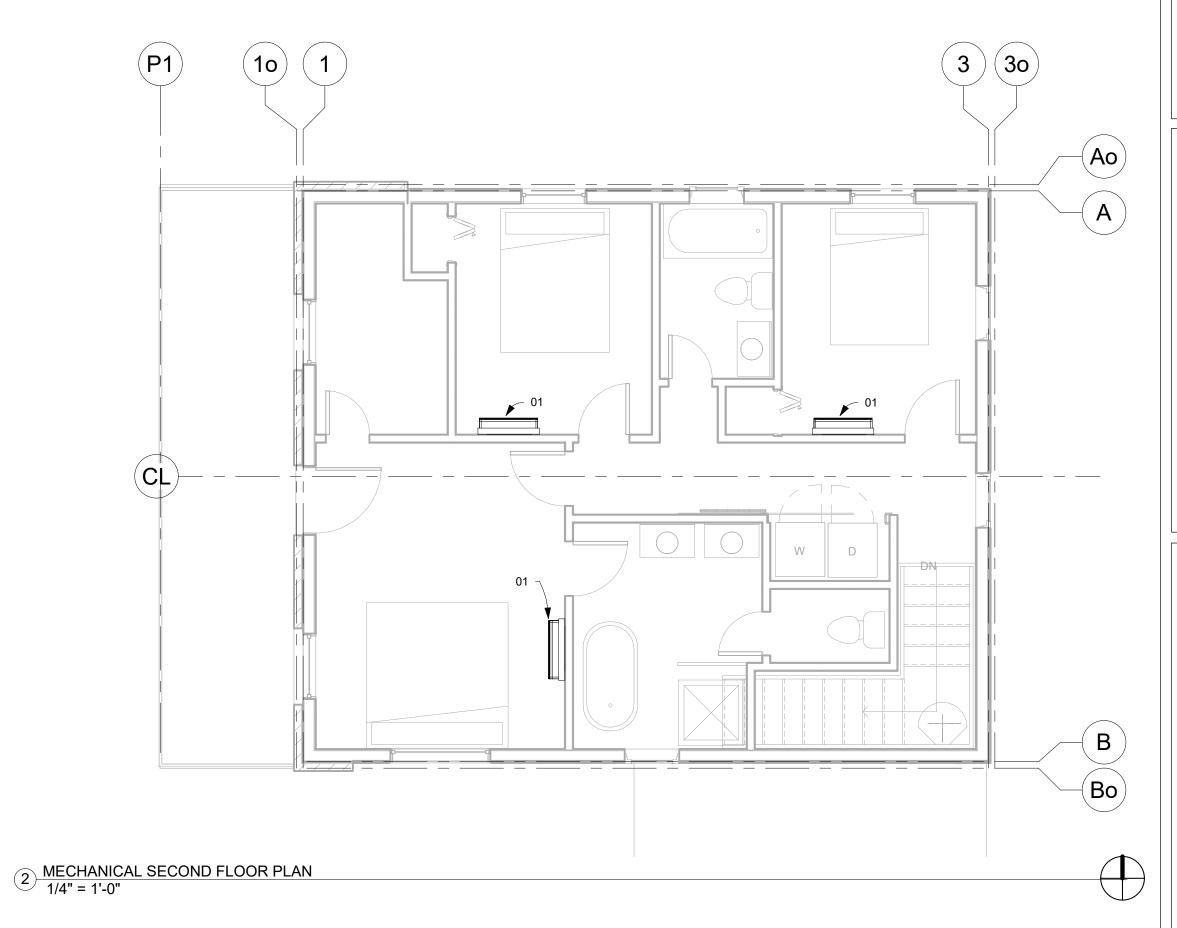

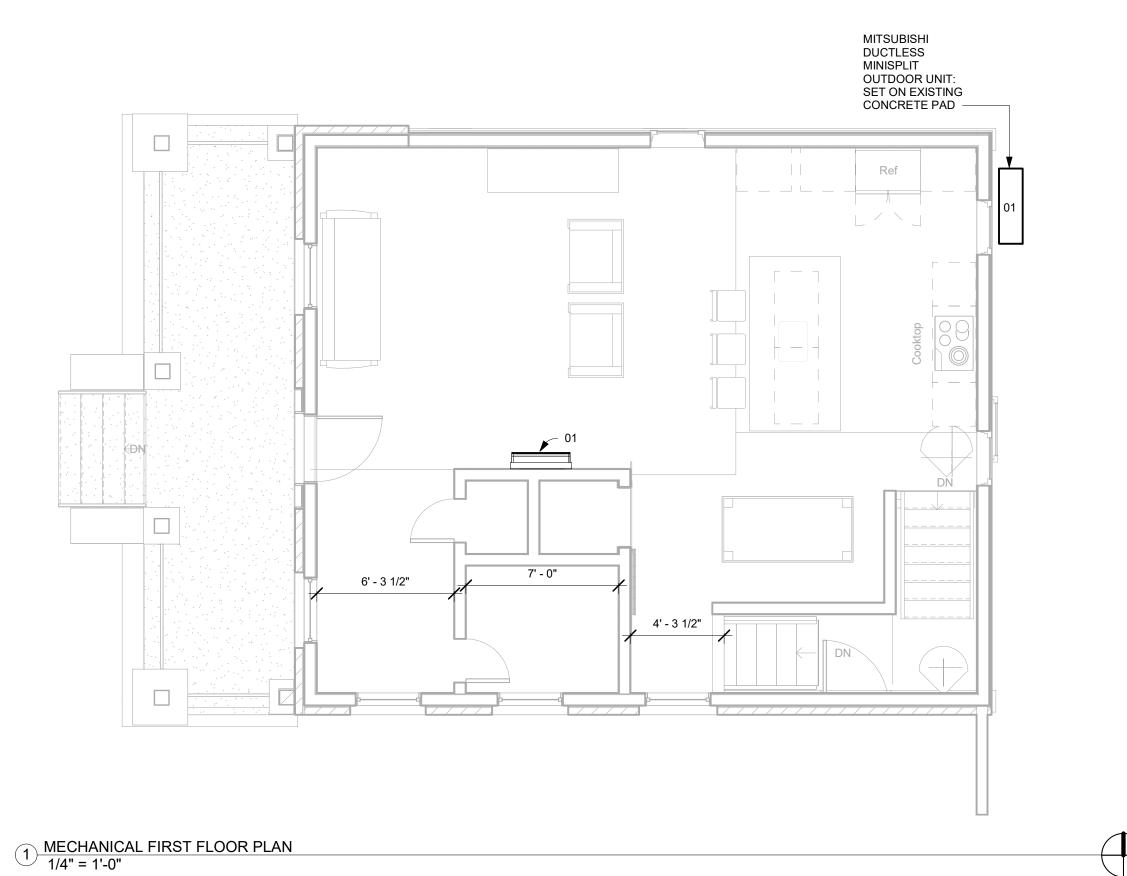



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Tandem House 2

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MECHANCIAL FLOOR
PLANS

Project number 2020-C01

Date 01.29.2021

Drawn by Author

Checked by Checker

M-1.00

1/28/2021 9:36:47 PM


PLUMBING NOTES


1. MAXIMUM HOT WATER PIPE RUN NOT TO EXCEED 50 FT PER LEED. FOUR (4) ELECTRIC ON-DEMAND TANKLESS WATER HEATERS TO BE INSTALLED AS FOLLOWS:


8 KW ECOSMART: (2) TO SERVE LEVEL 1 18 KW ECOSMART: (1) TO SERVE BASEMENT 36 KW ECOSMART: (1) TO SERVE LEVEL 2

2. PLUMBING CONTRACTOR TO ENSURE ALL WORK COMPLIES WITH CODE

3. UNDERSLAB PLUMBING SHOWN ON SHEET S-1.00

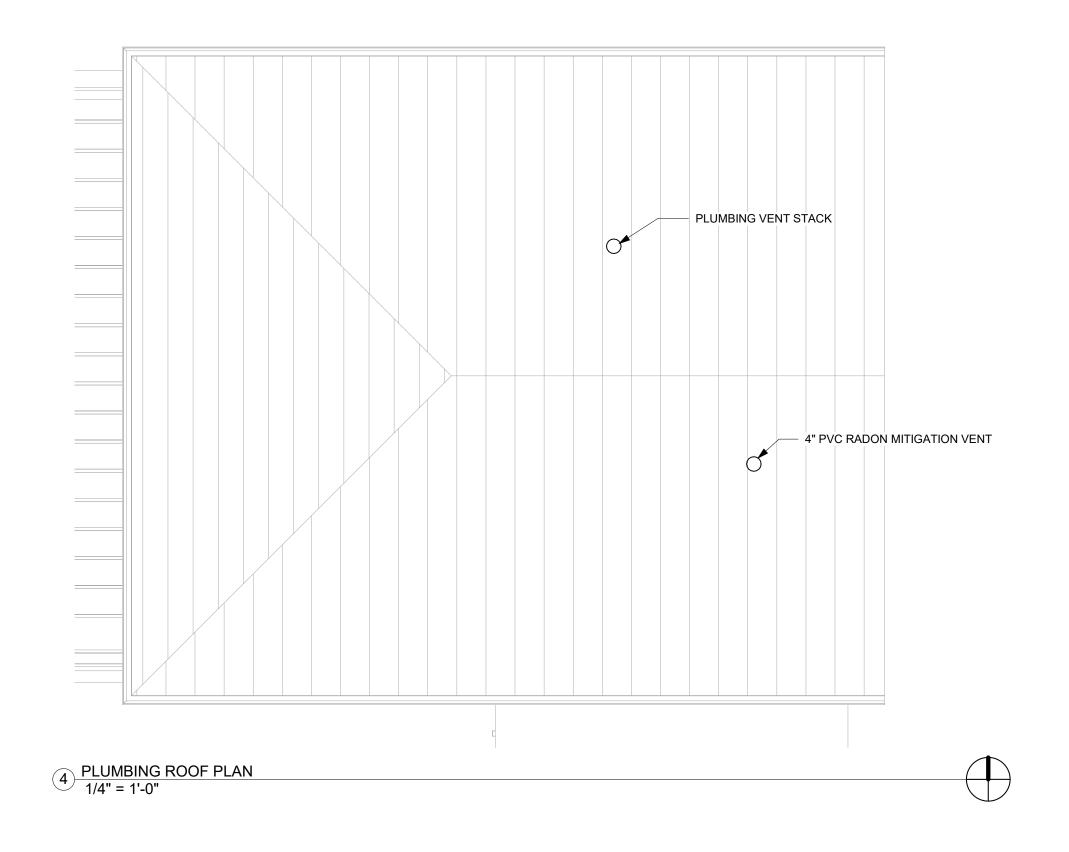

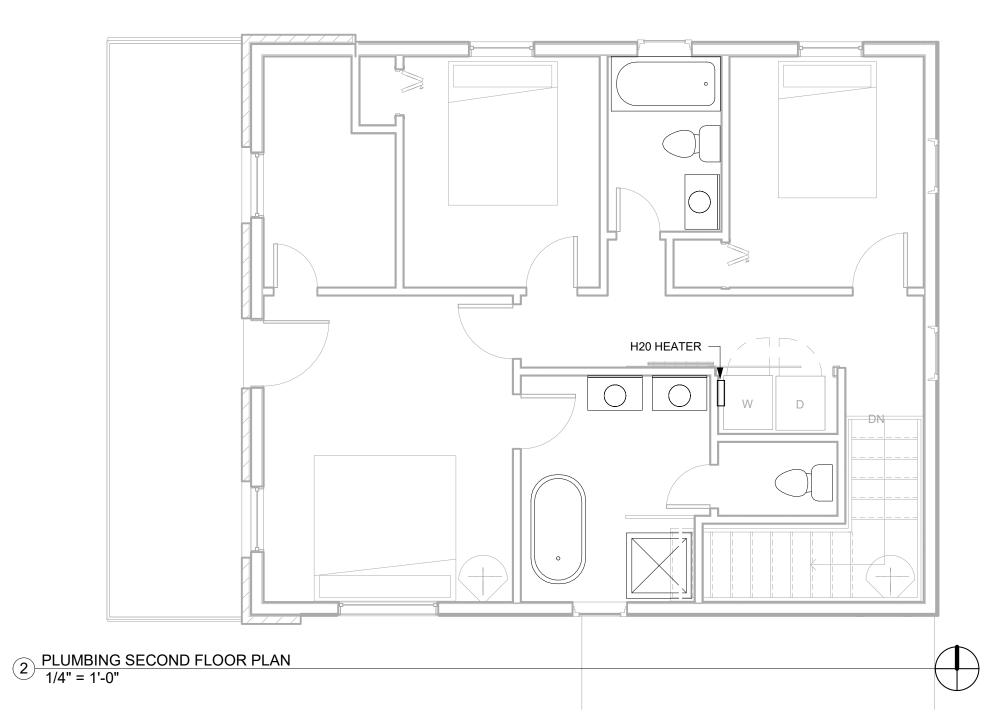

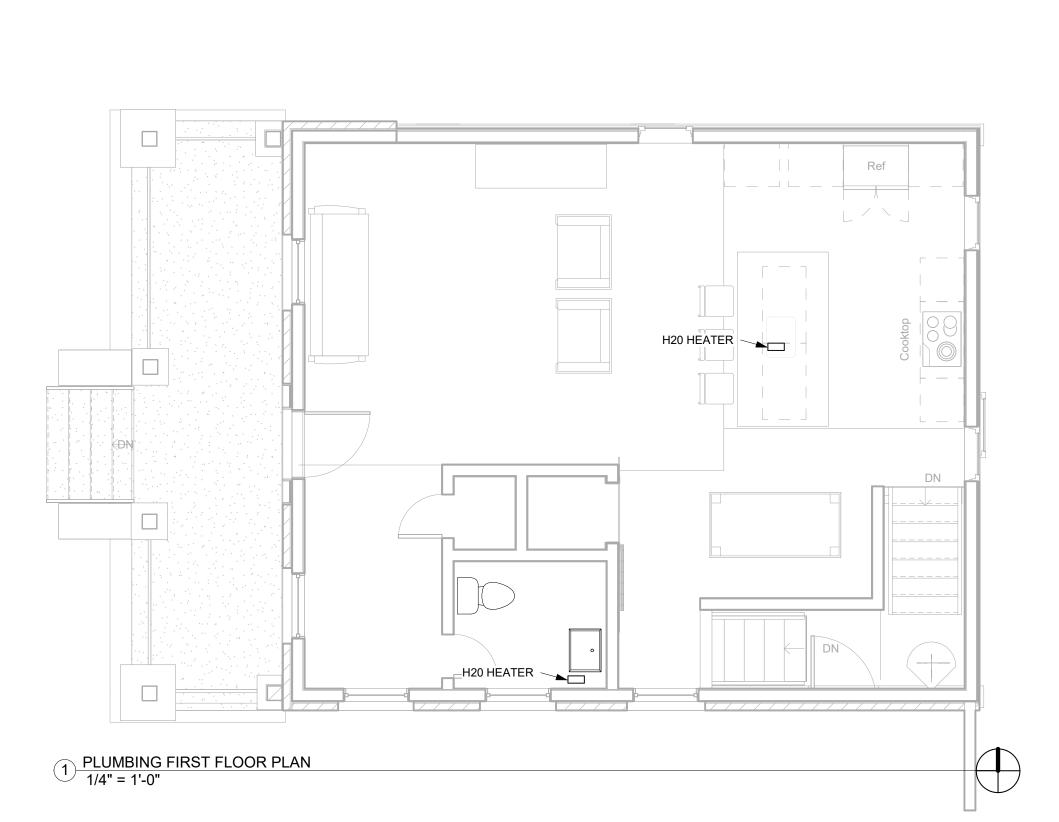



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Tandem House 2

3634 WYANDOT ST DENVER, CO 80211

REV	DESCRIPTION	DATE
	CONSTRUCTION DOCUMENTS	01.29.2021

PLUMBING PLANS

Project number 2020-CO1


Date 01.29.2021

Drawn by Author

Checked by Checker

Scale

P-1.00

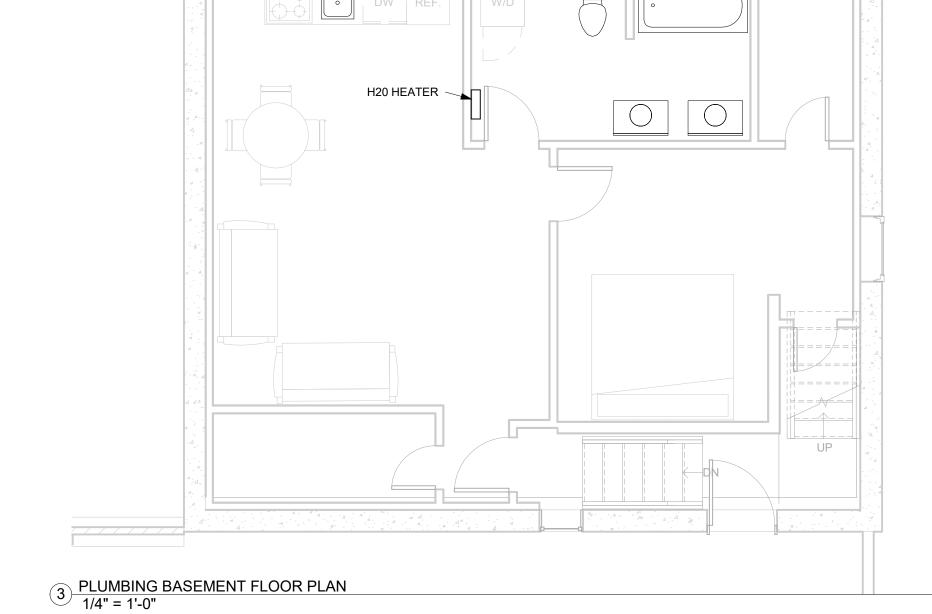

DESIGN LOADS

1. <u>GOVERNING CODE</u>: A. 2018 IRC B. 2019 DENVER AMENDMENTS

2. ROOF LOAD
A. SNOW LOAD
B. DEAD LOADS (ACTUAL):
C. SOLAR PANELS
0.6 PS

C. SOLAR PANELS 0.6 PSF

3. FLOOR LOAD
A. ROOMS (NON BEDROOM) 40 PSF
B. BEDROOMS: 30 PSF
C. GARAGES: 50 PSF

4. <u>SEISMIC DESIGN CATEGORY:</u> B

D. BALCONIES:

E. STAIRS:

GENERAL STRUCTURAL NOTES

1. ALL WORK SHALL BE PERFORMED IN ACCORDANCE WITH GEOTECHNICAL REPORT PREPARED BY KORDZIEL ENGINEERING, DATED SEPTEMBER 27, 2020 PROJECT NUMBER 1959B.

40 PSF

40 PSF

2. SEE SHEET A-0.02 FOR ADDITIONAL STRUCTURAL NOTES.


3.. WEB JOISTS ARE UNSTABLE UNTILL BRACED LATERALLY. BLOCKING, HANGARS AND/OR SHEATHING MUST BE PROPERLY INSTALLED PRIOR TO LOADING.

4. FRAMING AND LOADING DETAILS AT SIP PANELS TO BE CONFIRMED WITH APPROVED SIP PANEL LAYOUT SHOP DRAWINGS.


5. FLOOR SHEATHING SHALL BE 3/4" TONGUE & GROOVE, GLUED AND NAILED, UNLESS NOTED OTHERWISE.


6. WHERE SIP DETAILS DEVIATE FROM IRC SECTION R610, ENGINEERED SHOP DRAWINGS WILL BE PROVIDED BY THE SIP PANEL MANUFACTURER TO MEET ALL REQUIREMENTS OF WALL BRACING REQUIREMENTS AND ALLOWABLE PANEL HEIGHTS.

7. ROOF DESIGN HAS CONSIDERED GRAVITY AND WIND LOADS OF SPECIFIED SOLAR PANEL MODULES.

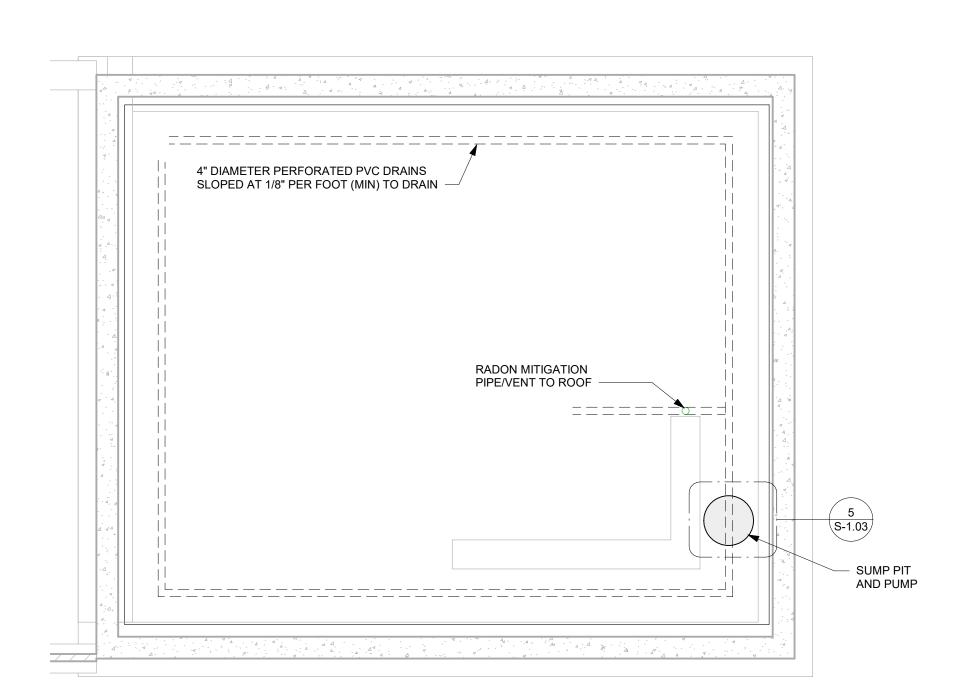

3 PLUMBING - UNDERSLAB
1/4" = 1'-0"

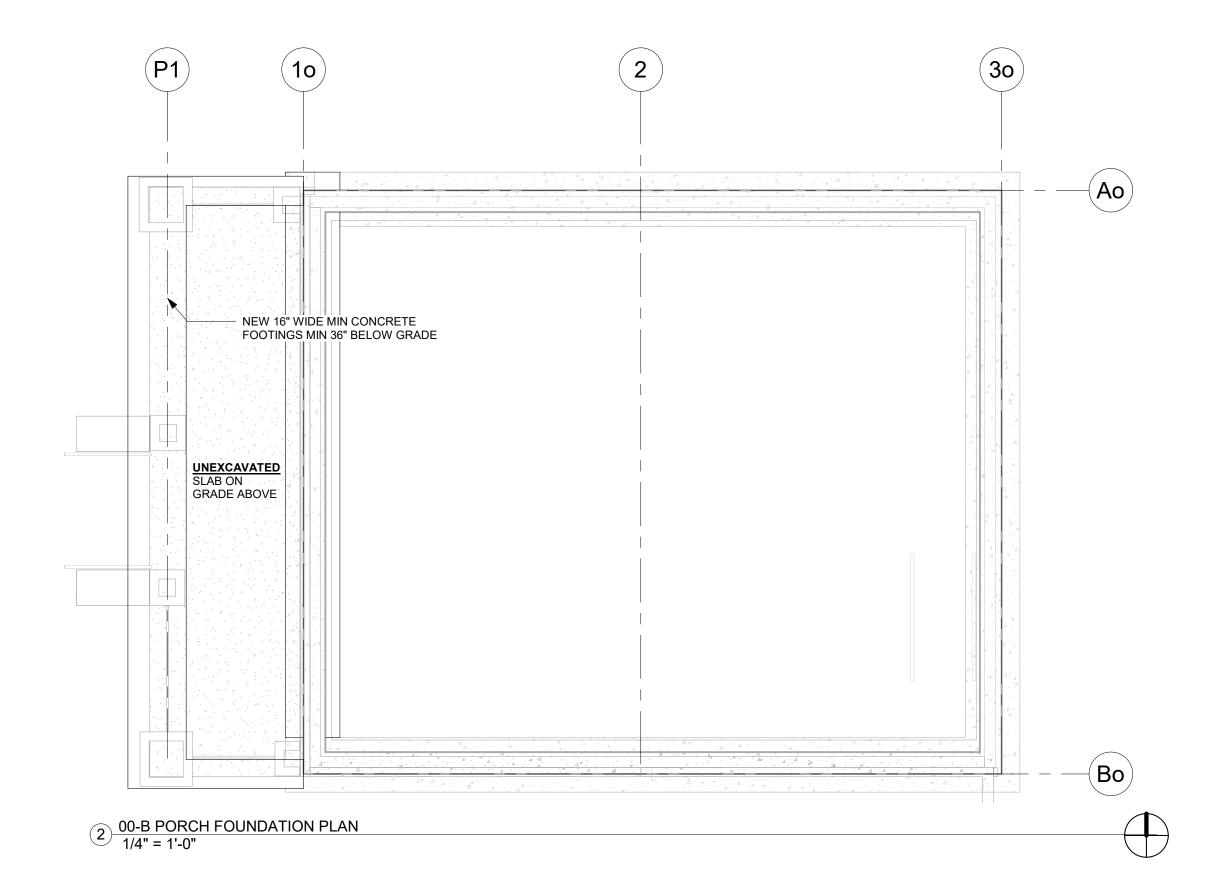

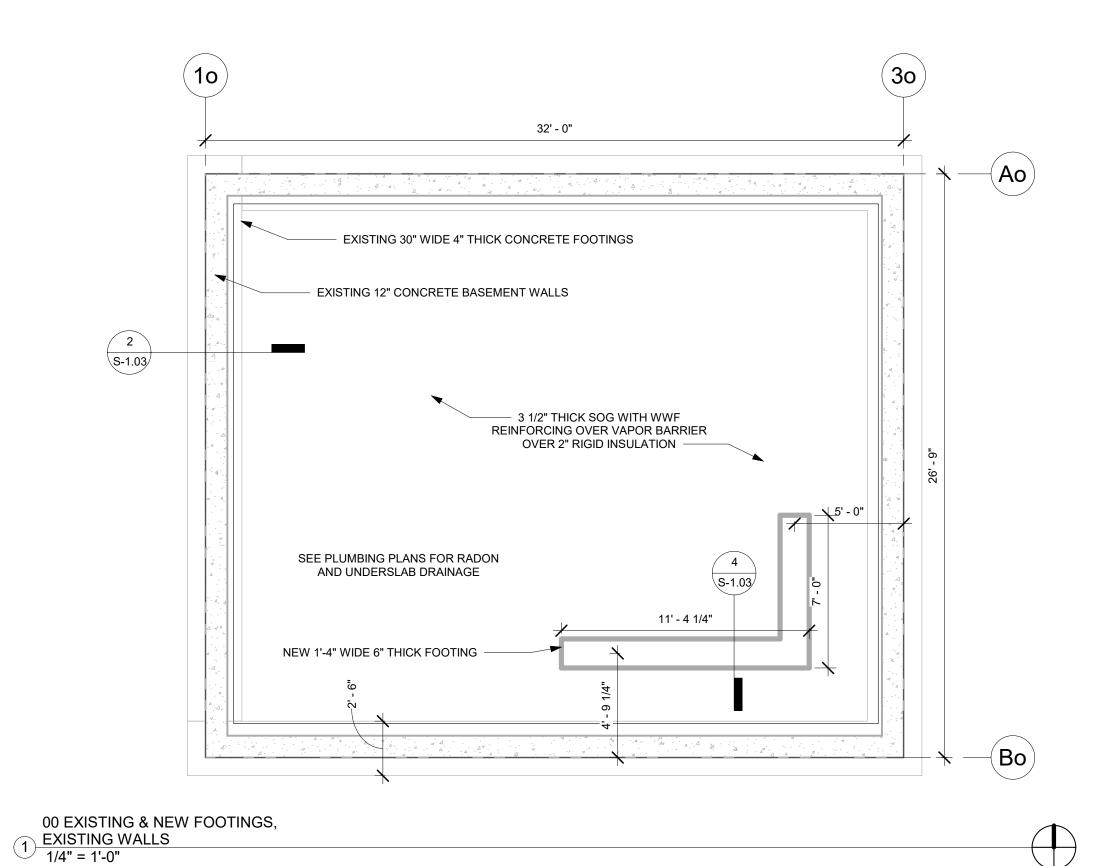

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Tandem House 2

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REV	DESCRIPTION	DATE
	CONSTRUCTION DOCUMENTS	01.29.202

FOUNDATION PLANS
& NOTES

Project number	2020-CO ²
Date	01.29.202
Drawn by	Autho
Checked by	Checke

S-1.00
Scale 1/4" = 1'-0"

DESIGN LOADS

1. GOVERNING CODE: A. 2018 IRC

B. 2019 DENVER AMENDMENTS

2. ROOF LOAD
A. SNOW LOAD
B. DEAD LOADS (ACTUAL):
C. SOLAR PANELS
0.6 PSF

3. <u>FLOOR LOAD</u>
A. ROOMS (NON BEDROOM) 40 PSF

B. BEDROOMS: 30 PSF C. GARAGES: 50 PSF D. BALCONIES: 40 PSF E. STAIRS: 40 PSF

4. <u>SEISMIC DESIGN CATEGORY:</u> B

GENERAL STRUCTURAL NOTES

1. ALL WORK SHALL BE PERFORMED IN ACCORDANCE WITH GEOTECHNICAL REPORT PREPARED BY KORDZIEL ENGINEERING, DATED SEPTEMBER 27, 2020 PROJECT NUMBER 1959B.

2. SEE SHEET A-0.02 FOR ADDITIONAL STRUCTURAL NOTES.


3.. WEB JOISTS ARE UNSTABLE UNTILL BRACED LATERALLY. BLOCKING, HANGARS AND/OR SHEATHING MUST BE PROPERLY INSTALLED PRIOR TO LOADING.


4. FRAMING AND LOADING DETAILS AT SIP PANELS TO BE CONFIRMED WITH APPROVED SIP PANEL LAYOUT SHOP DRAWINGS.


5. FLOOR SHEATHING SHALL BE 3/4" TONGUE & GROOVE, GLUED AND NAILED, UNLESS NOTED OTHERWISE.

6. WHERE SIP DETAILS DEVIATE FROM IRC SECTION R610, ENGINEERED SHOP DRAWINGS WILL BE PROVIDED BY THE SIP PANEL MANUFACTURER TO MEET ALL REQUIREMENTS OF WALL BRACING REQUIREMENTS AND ALLOWABLE PANEL HEIGHTS.

7. ROOF DESIGN HAS CONSIDERED GRAVITY AND WIND LOADS OF SPECIFIED SOLAR PANEL MODULES.

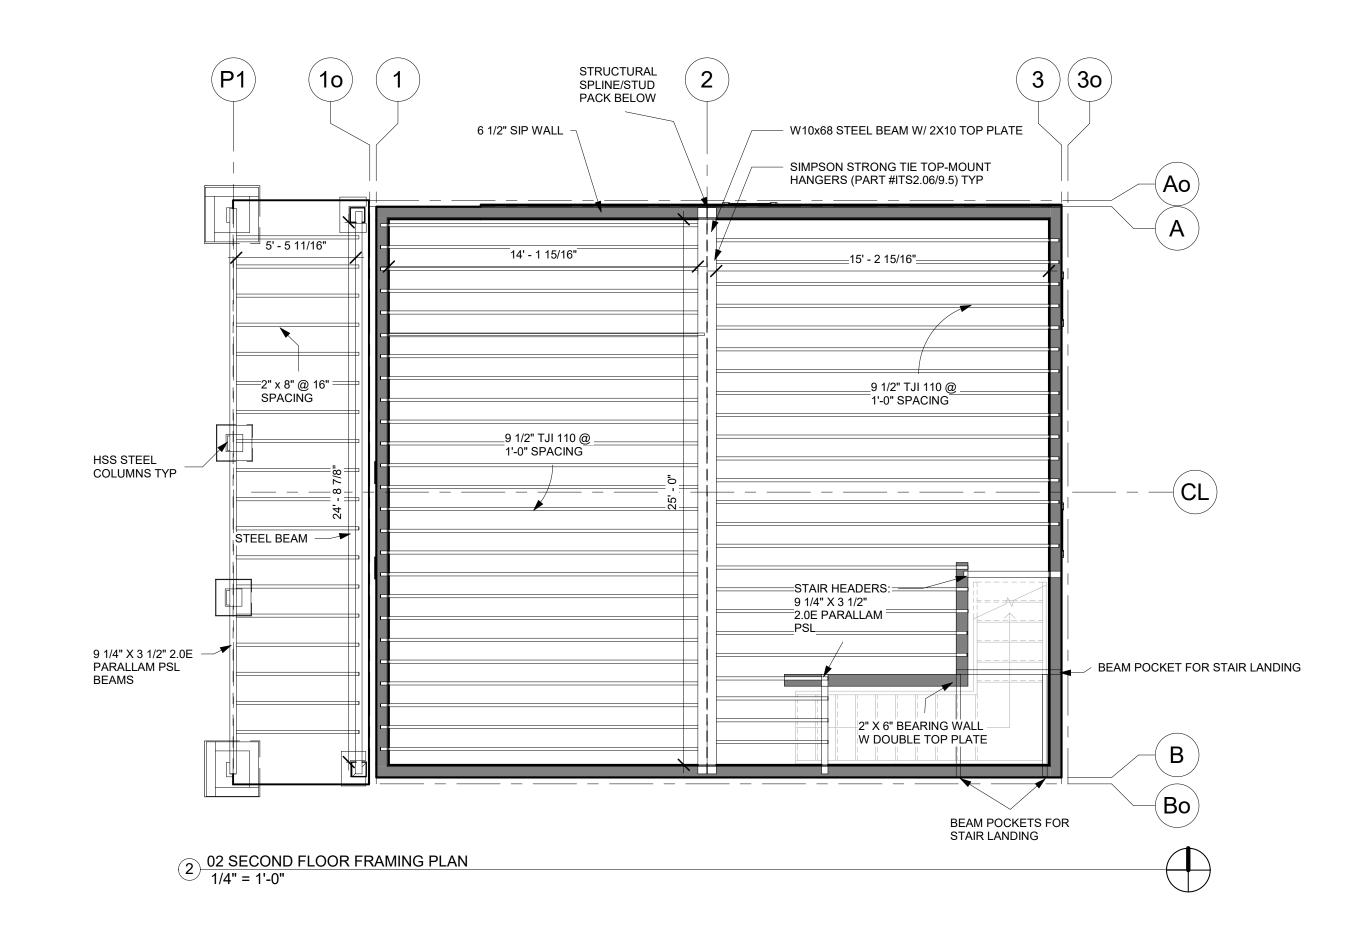

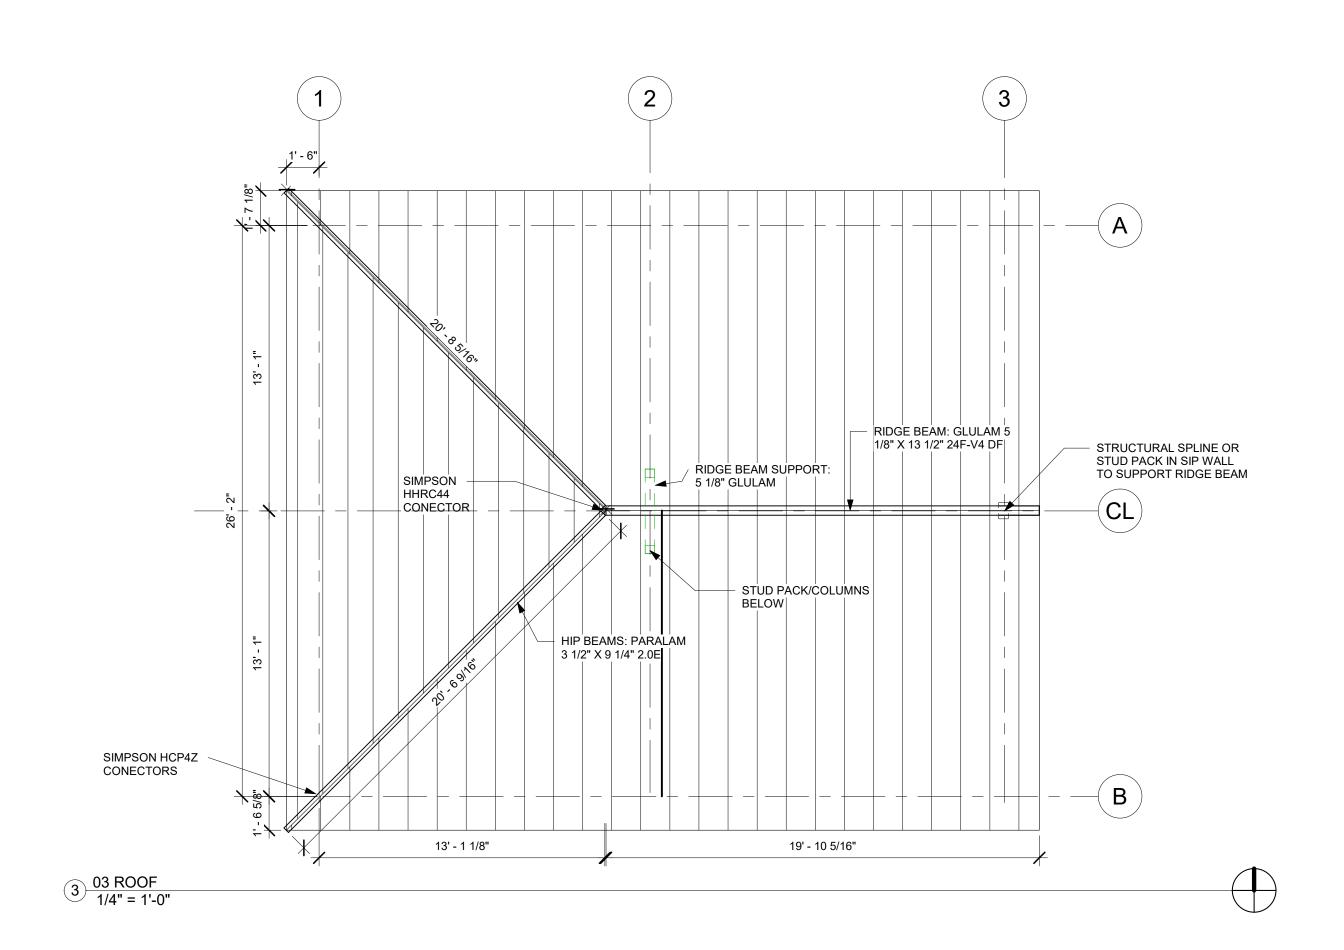

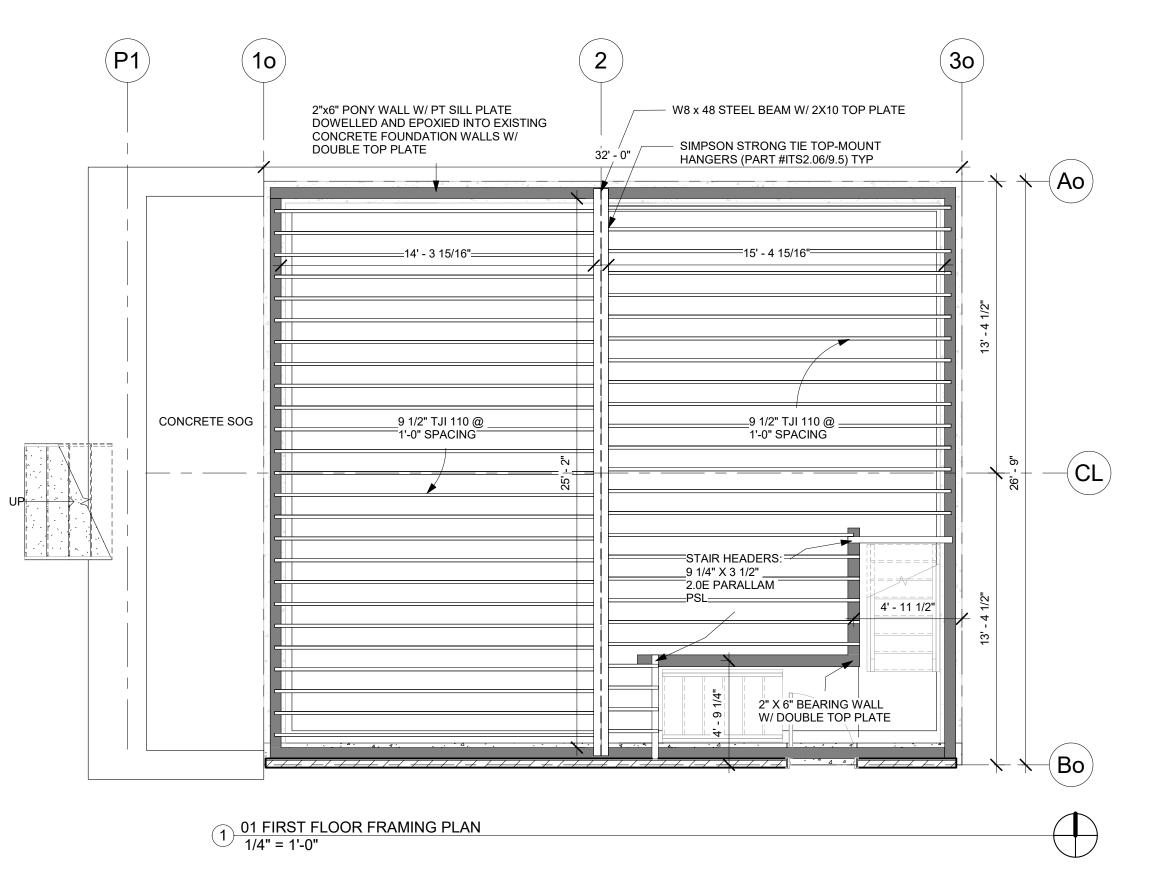

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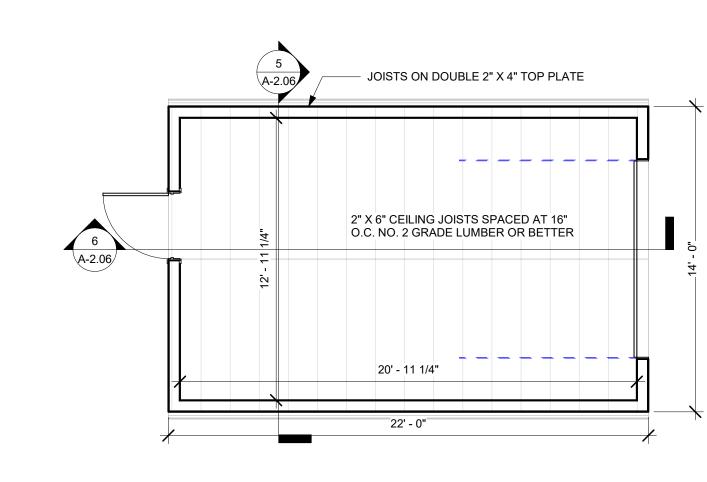
3634 WYANDOT ST DENVER, CO 80211

REV	DESCRIPTION	DATE
	CONSTRUCTION DOCUMENTS	01.29.2021


STRUCTURAL FRAMING PLANS


2020-CO1 01.29.2021
01 29 2021
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Author
Checker

S-1.01
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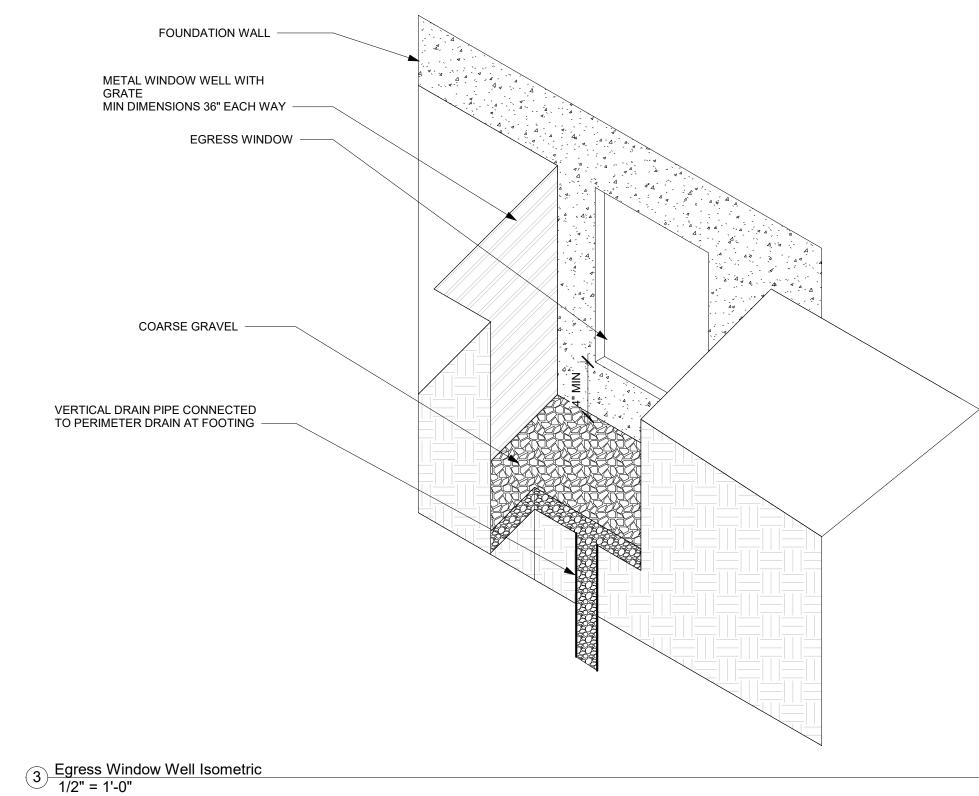
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	CONSTRUCTION DOCUMENTS	01.29.202


GARAGE PLANS &
DETAILS


Project number	2020-CO1
Date	01.29.2021
Drawn by	Author
Checked by	Checker
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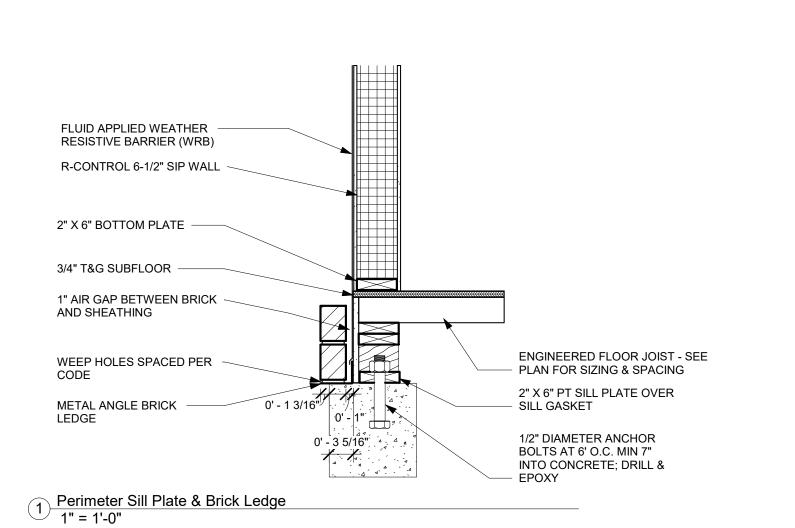
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Scale As indicated

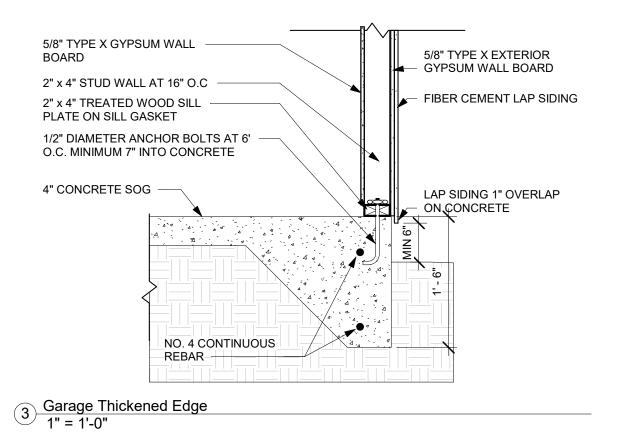MO 607700 1000/180/1

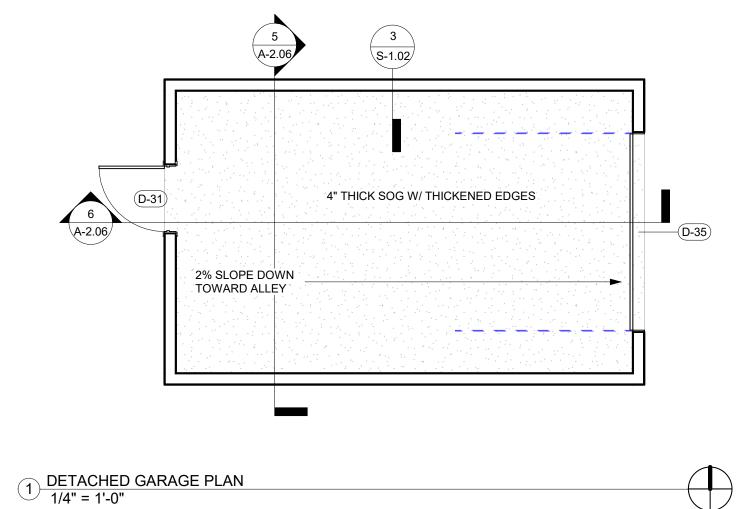



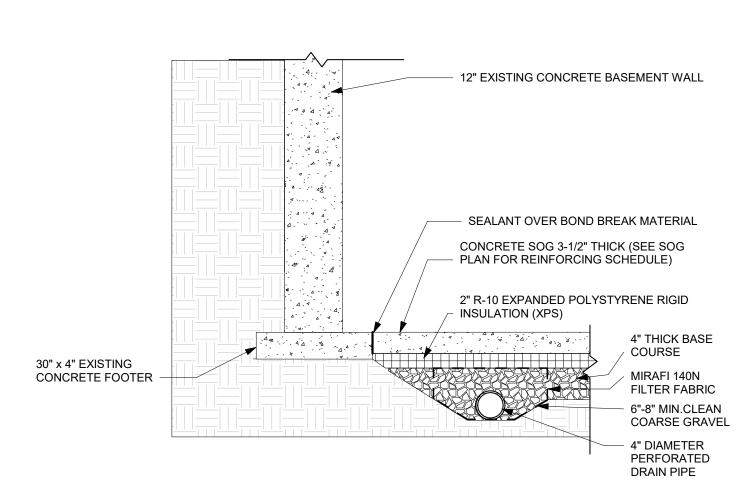

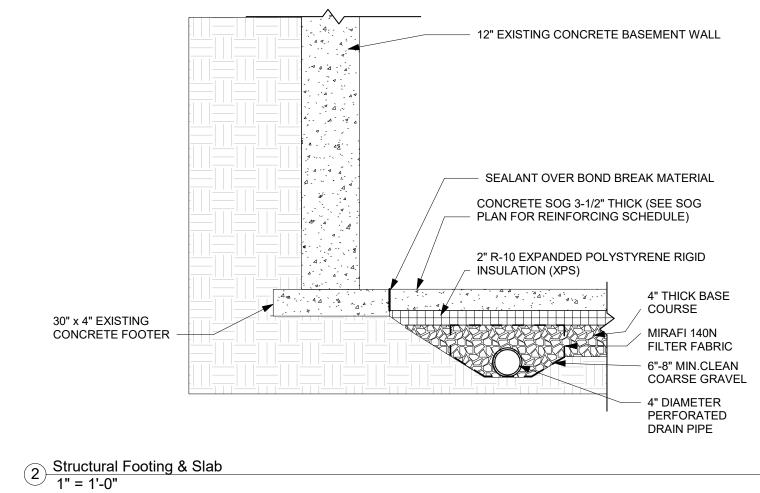




Tandem House 2


3634 WYANDOT ST DENVER, CO 80211

REV	DESCRIPTION	DATE	
	CONSTRUCTION DOCUMENTS	01.29.20	

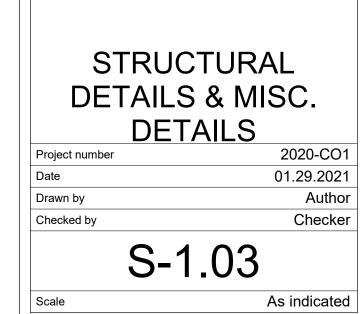

DISCHARGE PIPE TO YARD CHECK VALVE - SUMP PIT AND PUMP 4" DIAMETER PERFORATED DRAIN PIPE COARSE GRAVEL

5 Basement Sump Detail
1" = 1'-0"

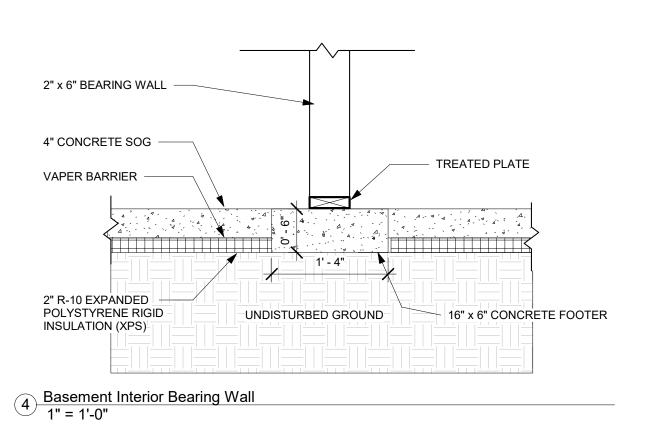

As indicated